

AMENDMENT #5


SITE SAFETY PLAN FOR FOUNDATION ENHANCEMENTS AT 270 PARK AVE, MANHATTAN, NY

FOUNDATION WORK :

- ALT 2 INSTALLATION OF CAISSONS AND PILE CAPS (CEL, SUB)
- ALT 2 FOUNDATION ENHANCEMENTS AT D1 LINE
- ALT-2 PARTIAL HAND DEMOLITION OF SUB-CELLAR 2 SLAB
- ALT-2 PARTIAL MECHANICAL DEMOLITION OF CELLAR, SUB-CELLAR 1 TO 3 SLABS

- JOB No. 121189285
- JOB No. 121204810
- JOB No. 140883836
- JOB No. 121207087 ←

AMENDMENT TO THIS APPLICATION

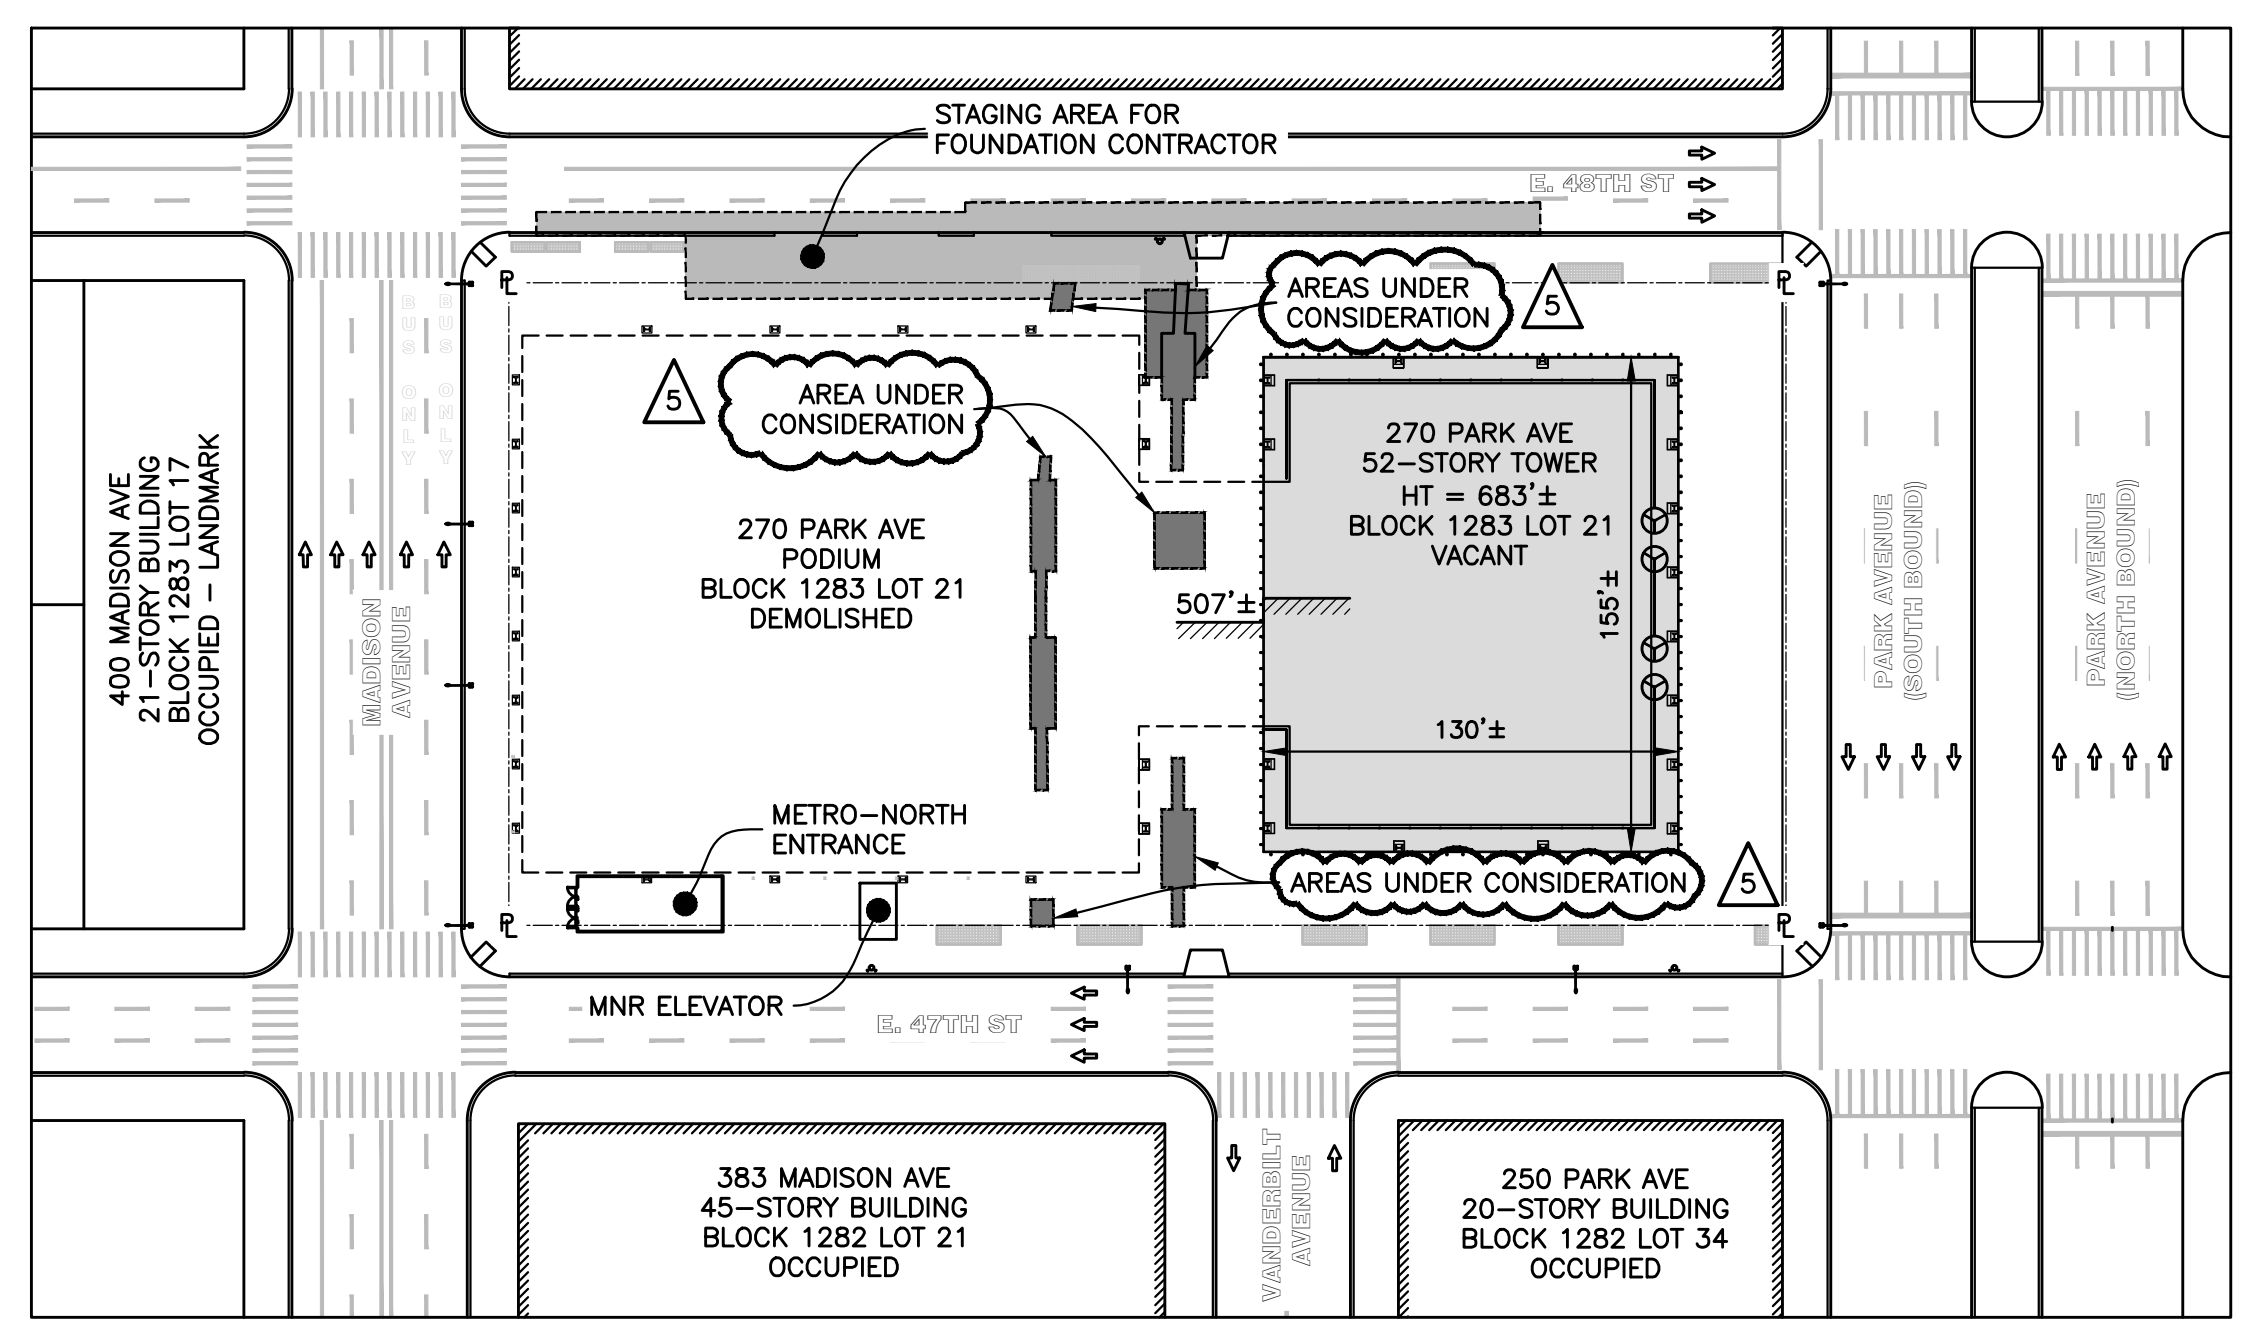

KEY PLAN
Scale : 1" = 60'

No.	DATE	DESCRIPTION	BY
5	03/04/21	REVISED COVER PAGE	KG
4	01/08/21	REVISED COVER PAGE	KC
3	12/01/20	REVISED COVER PAGE	KC
2	06/03/20	REVISED COVER PAGE	KC
1	03/06/20	REVISED COVER PAGE	KC

HOWARD I. SHAPIRO & ASSOCIATES
CONSULTING ENGINEERS, P.C.

266 MERRICK ROAD, SUITE 300, LYNBROOK, N.Y. 11563
TEL: (516) 791-2600 FAX: (516) 791-5425

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CLIENT
JOHN CIVETTA & SONS, INC.
1123 BRONX RIVER AVE, BRONX, NY 10472
PH: (718) 589-9000

PROJECT
SITE SAFETY FOR
FOUNDATION ENHANCEMENTS AT
270 PARK AVENUE, MANHATTAN, NY

ZONING INFORMATION
BLOCK: 1283
LOT: 21
ZONE: C5-3
ZONING MAP: 8D
COMMUNITY BOARD: 105
BIN #: 1035421

PLACE STICKER HERE

EXAMINER'S STAMP HERE

TITLE SHEET

	DRAWING BY: KC DATE: 03/04/2021 PROJECT NO: 18211.03.00 ENGINEER: JS SCALE: AS NOTED CHK BY: JS DWG NO:
	SSSP-001.05 V: 2018\18211.03.00 1 OF 47

ASSOCIATED PERMIT LOG :

HOIST, SIDEWALK SHED, SCAFFOLD, & FENCE :

ALT-3 WEST HOIST COMPLEX (CARS 1 & 2)	140806894
ALT-3 CONSTRUCTION FENCE	M00078455
ALT-3 SIDEWALK SHED	M00086485
ALT-3 SIDEWALK SHED	M00091254
ALT-3 SIDEWALK SHED	M00098827
ALT-3 SIDEWALK SHED	M00098832
ALT-3 SIDEWALK SHED (OVER MNR EXIT)	M00127029
ALT-2 HEAVY-DUTY PLATFORM (GRD)	140842257
ALT-2 LOADING DOCK (GRD)	123893331

SCAFFOLD INSTALLATION :

ALT-3 NEEDLE BEAM PLATFORM & SCAFFOLD (TOWER FLOORS 41-53)	M00105137-1-SF
ALT-3 NEEDLE BEAM PLATFORM & SCAFFOLD (TOWER FLOORS 28-41)	M00134730-1-SF
ALT-3 NEEDLE BEAM PLATFORM & SCAFFOLD (TOWER FLOORS 16-29)	M00134735-1-SF
ALT-3 TOWER BASE SCAFFOLD (TOWER FLOORS 1 TO 16)	M00140916
ALT-3 SCAFFOLD ON TOP OF SIDEWALK SHED (PODIUM FLOORS 2-14)	M00133856-11-SF

DEMOLITION :

ALT-2 REMOVAL OF HVAC AND MECH. EQ & EQ PERMIT	121204785
ALT-2 STANDPIPE CONVERSION	123892895
ALT-2 TROLLEY BEAM & WINCH	123885901
ALT-2 DEBRIS SHAFT	140850285
ALT-2 DEBRIS SHAFT #2 EAST	140864223
FULL DEMOLITION	123656640
TEMPORARY ELECTRIC LIGHT & POWER	M00141508-11-EL
TEMPORARY ELECTRIC BUS DUCT RE-FEED	M00141992-11-EL

CRANE NOTIFICATIONS :

TOWER CRANE FOR DEMOLITION	1701/19
MOBILE CRANE FOR FOUNDATION WORK	902/19
MOBILE CRANE FOR DEMOLITION	758/20
MOBILE CRANE FOR CELLAR DEMOLITION	149/21
MOBILE CRANE FOR STEEL ERECTION	374/20
SOUTH CRAWLER CRANE FOR STEEL ERECTION	375/20
MOBILE CRANE FOR STEEL ERECTION	376/20
NORTH CRAWLER CRANE FOR STEEL ERECTION	377/20

FOUNDATION WORK :

ALT-2 INSTALLATION OF CAISSONS AND PILE CAPS (CEL. SUB)	121189285
ALT-2 FOUNDATION ENHANCEMENTS AT D.1 LINE	121204610
ALT-2 HAND DEMOLITION OF PORTION OF SUB-CELLAR 2	140883836
ALT-2 MECHANICAL DEMOLITION OF PORTION OF SUB-CELLAR 2	121207087
ALT-2 SUPPORT OF EXCAVATION AT TERRA FIRMA	140895366
ALT-3 HOIST COMPLEX	140926265

STATUS :	No.	DRAWING LIST :	ISSUE							
			10/7/19	03/06/20	06/03/20	11/24/20	01/08/21	03/04/21		
S	001	SSP-001.05								
-	002	SSP-002.00								
S	003	SSP-003.05								
-	004	SSP-004.00								
-	005	SSP-005.00								
-	006	SSP-006.00								
-	007	SSP-007.00								
-	008	SSP-008.00								
-	009	SSP-009.00								
-	010	SSP-010.00								
-	011	SSP-011.00								
-	012	SSP-012.00								
-	013	SSP-013.00								
S	016	SSP-201.03								
-	017	SSP-202.00								
-	018	SSP-203.00								
-	019	SSP-204.00								
-	020	SSP-205.00								
-	021	SSP-206.00								
-	022	SSP-207.00								
-	023	SSP-208.00								
-	024	SSP-301.00								
-	025	SSP-302.01								
-	026	SSP-303.00								
-	027	SSP-304.00								
-	028	SSP-305.00								
-	029	SSP-306.00								
-	030	SSP-307.00								
-	031	SSP-308.00								
S	032	SSP-309.01								
N	033	SSP-311.00								
N	034	SSP-312.00								
N	035	SSP-313.00								
N	036	SSP-314.00								
N	037	SSP-315.00								
N	038	SSP-316.00								
N	039	SSP-317.00								
-	040	SSP-401.00								
-	041	SSP-402.00								
-	042	SSP-403.00								
-	043	SSP-404.00								
-	044	SSP-405.00								
-	045	SSP-406.00								
-	046	SSP-407.00								
-	047	SSP-408.00								

* = NO CHANGE *N* = NEW SHEET *S* = SUPERSEDING *O* = OMITTED

● DRAWING BEING SUBMITTED

LEGEND

	FOUNDATION CONTRACTOR WORK AREA		PROPERTY LINE
	AREA UNDER CONSIDERATION		STEEL FRAMING
	HEAVY-DUTY SIDEWALK SHED		EXISTING GUARDRAIL
	ROOF PROTECTION		STANDARD GUARDRAIL
	COVER OVER OPENING		CONSTRUCTION FENCE
	HOIST COMMON PLATFORM		4' HIGH PLYWOOD FENCE w/ FULL HEIGHT WIRE MESH TYP.
	METRO-NORTH GRATING OVER VENTILATION STRUCTURE		2V:1H EXCLUSION ZONE
	FIRE DEPARTMENT CONNECTION FOR STANDPIPE TO REMAIN.		TEMP. STORMWATER LINE BY OTHERS
	STANDPIPE RISER		TEMP. ELECTRIC LINE BY OTHERS
	CAUTION / SAFETY NOTE		TEMP. WATER LINE BY OTHERS
	FIRE HYDRANT		CONCRETE JERSEY BARRIER WITH PLYWOOD FENCE ON TOP
	STREET LAMP		PLASTIC JERSEY BARRIER WITH CHAINLINK FENCE AND NETTING
	STREET SIGN		FLAGMAN / SECURITY GUARD
	MNR EMERGENCY EGRESS		1" STEEL PLATE
	EGRESS FOR FOUNDATION CONTRACTOR		DEBRIS SHIELD
	EGRESS FOR DEMOLITION CONTRACTOR		EXISTING STAIR
	EXISTING BUILDING COLUMN		EXISTING ELEVATOR
	DIRECTION OF TRAFFIC		SCAFFOLD WITH DEBRIS NETTING

No.	DATE	DESCRIPTION	BY
5	03/04/21	REVISED DRAWING LIST/UPDATE PERMIT LOG	KG
4	01/06/21	REVISED DRAWING LIST/UPDATE PERMIT LOG	KC
3	12/01/20	REVISED DRAWING LIST	KC
2	06/03/20	REVISED DRAWING LIST	KC
1	03/06/20	REVISED DRAWING LIST/UPDATE PERMIT LOG	KC

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PROJECT

SITE SAFETY FOR
FOUNDATION ENHANCEMENTS AT
270 PARK AVENUE, MANHATTAN, NY

ZONING INFORMATION

BLOCK: 1283
LOT: 21
ZONE: C5-3
ZONING MAP: 8D
COMMUNITY BOARD: 105
BIN #: 1035421

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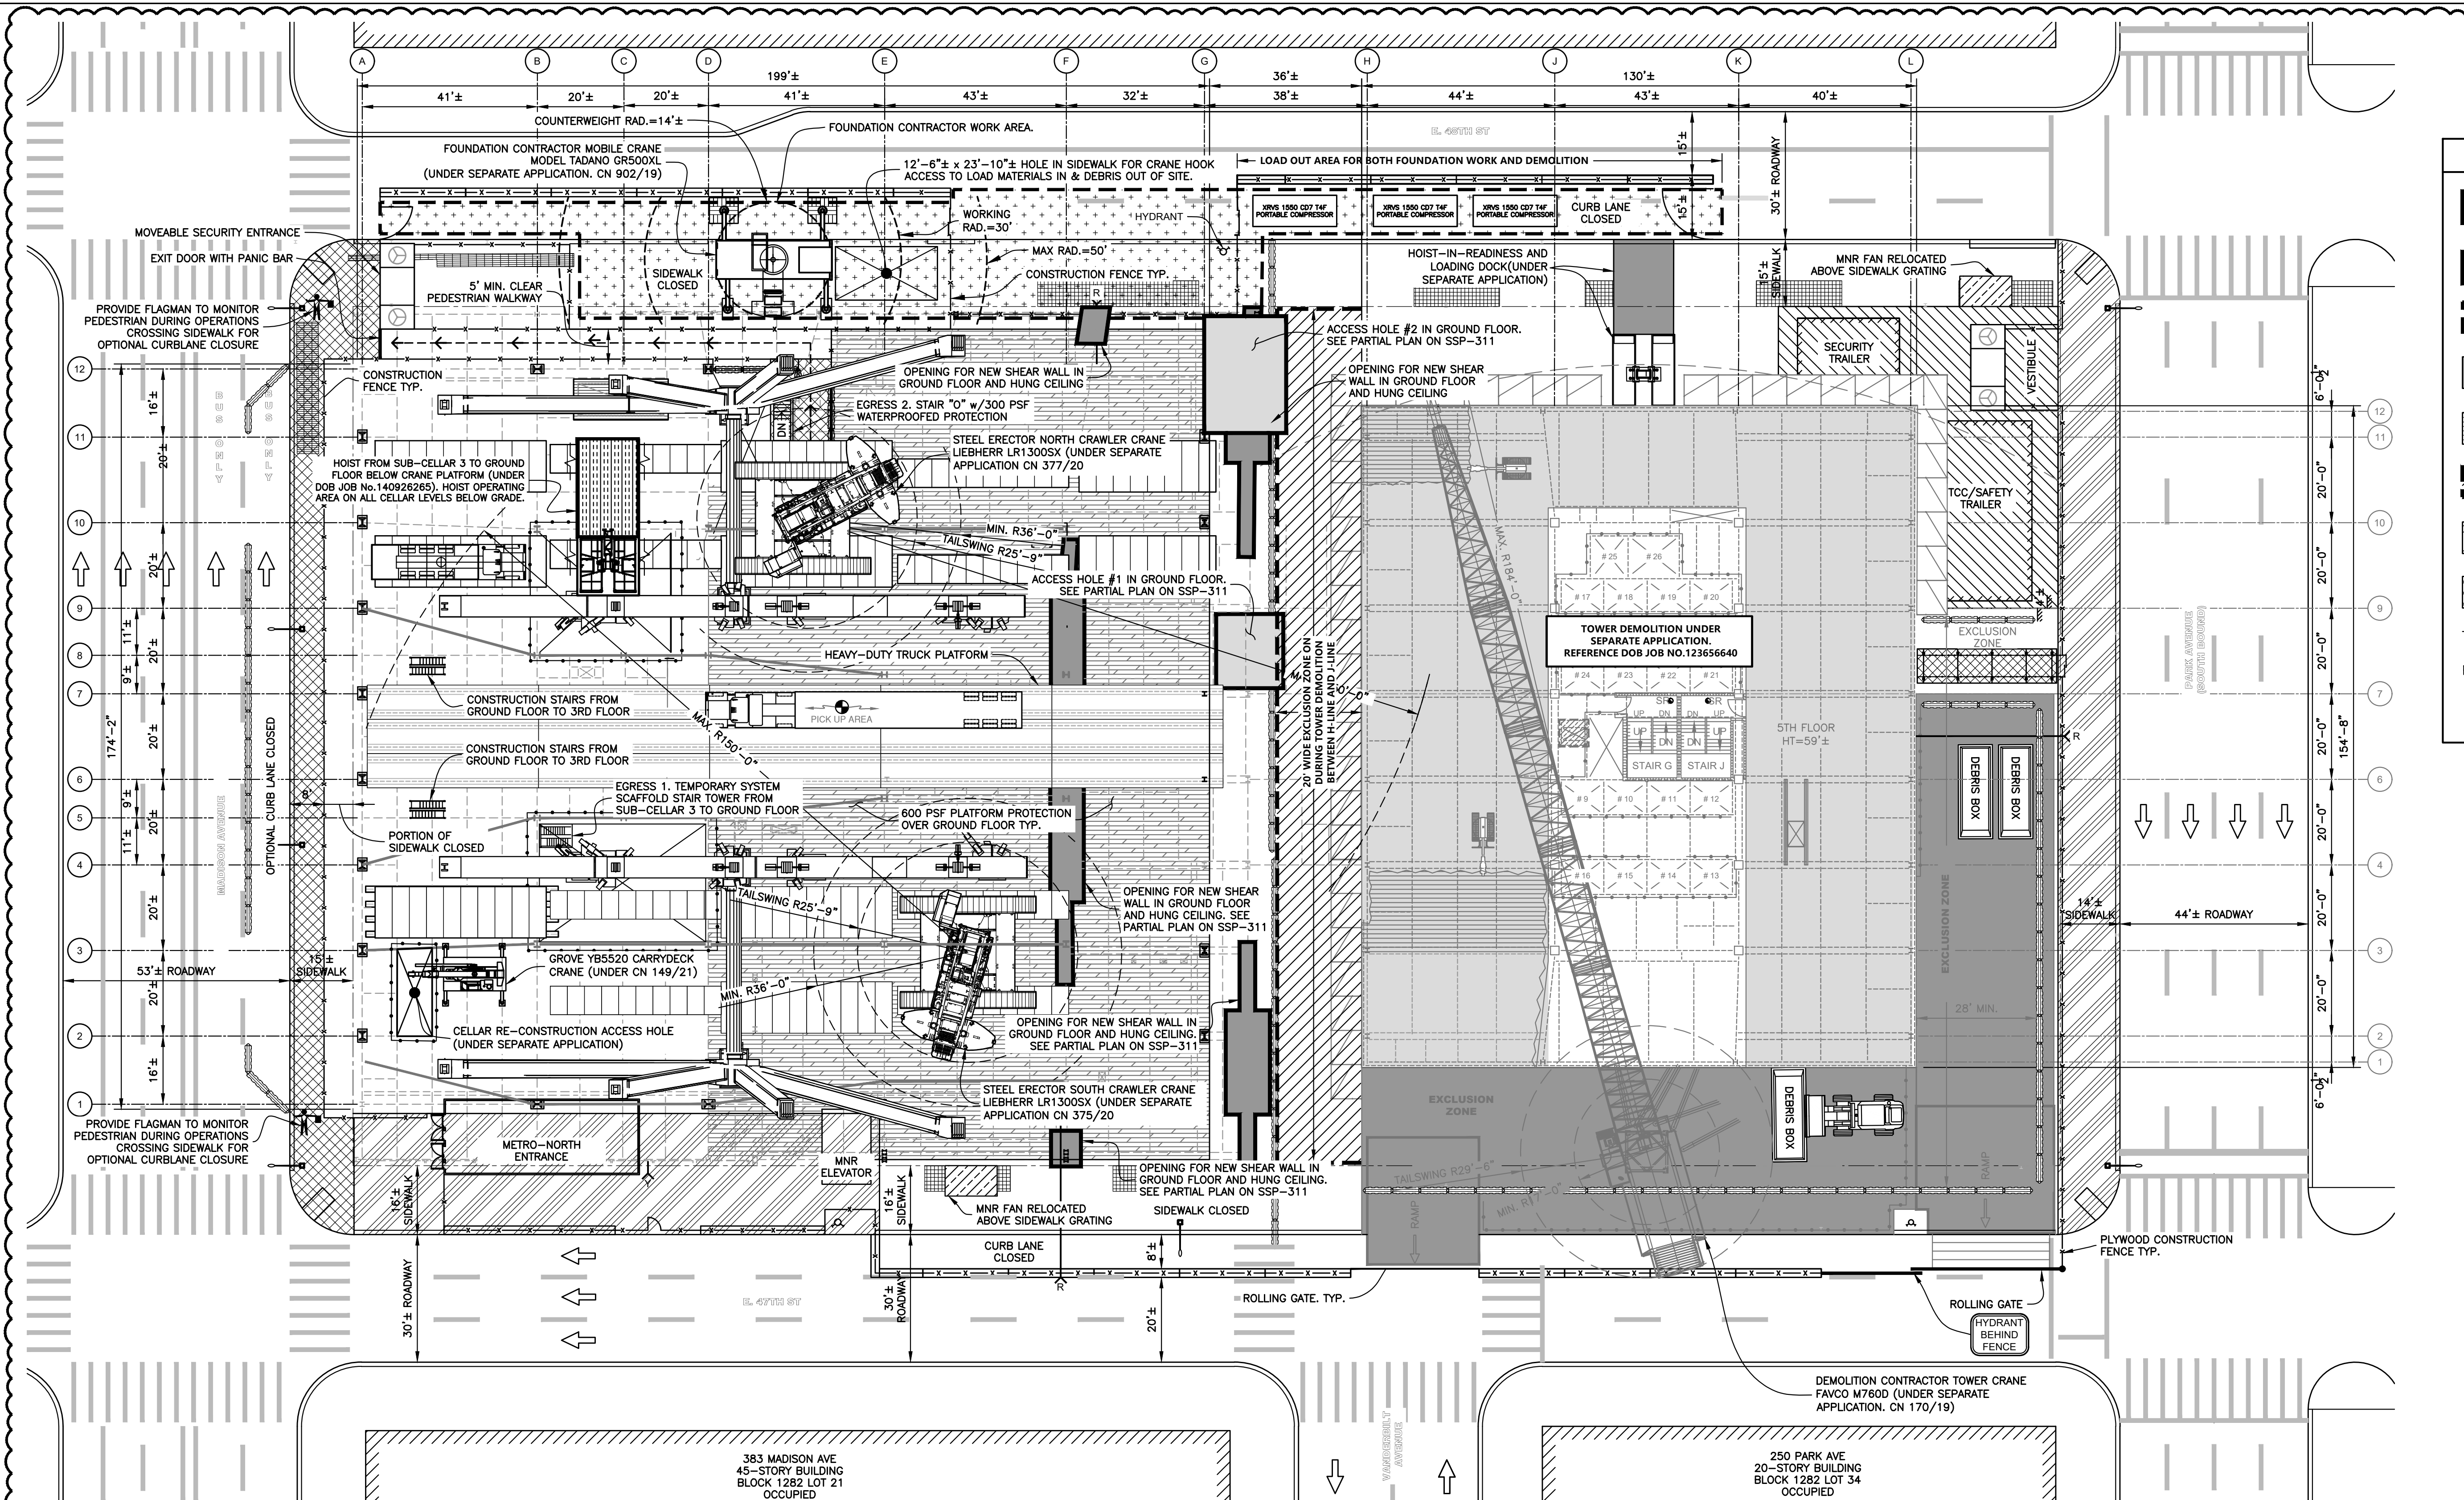
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TITLE

DRAWING LIST, LEGEND &
ASSOCIATED PERMIT LOG

SEAL & SIGNATURE
Sk Ali-Shafin
APPROVED
AMENDED PLAN
03/12/2021
CSC SSP

DRAWING BY: KC DATE: 03/04/2021
PROJECT NO: 18211.03.00
ENGINEER: JS
SCALE: AS NOTED
CHK BY: JS
DWG NO: **SSP-003.05**



LEGEND

[Symbol]	NEW SHEAR WALL OPENINGS IN GROUND FL. & HUNG CEILING
[Symbol]	NEW ACCESS OPENINGS IN GROUND FL.
[Symbol]	FOUNDATION CONTRACTOR WORK AREA TYP.
[Symbol]	HEAVY-DUTY PLATFORM
[Symbol]	600 PSF PLATFORM PROTECTION OVER GROUND FLOOR TYP.
[Symbol]	EXCLUSION ZONE
[Symbol]	16' HIGH SIDEWALK SHED TYP.
[Symbol]	8' HIGH SIDEWALK SHED TYP.
[Symbol]	STANDARD GUARDRAILS TYP.
[Symbol]	CONCRETE JERSEY BARRIER TYP.
[Symbol]	YODOCKS TYP.

No.	DATE	DESCRIPTION	BY
5	03/04/21	UPDATED OVERALL SITE PLAN, ADD F-LINE AND SA-LINE OPENINGS.	KC
3	11/24/20	UPDATED OVERALL SITE PLAN, ADD K-LINE OPENING	KC
2	06/03/20	MODIFIED D.J LINE OPENING	KC
2	06/03/20	ADD GROUND FLOOR OPENINGS	KC

HOWARD I. SHAPIRO & ASSOCIATES
 CONSULTING ENGINEERS, P.C.
 266 MERRICK ROAD, SUITE 500, LYNBROOK, N.Y. 11563
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PROJECT
 SITE SAFETY FOR FOUNDATION ENHANCEMENTS AT 270 PARK AVENUE, MANHATTAN, NY

ZONING INFORMATION
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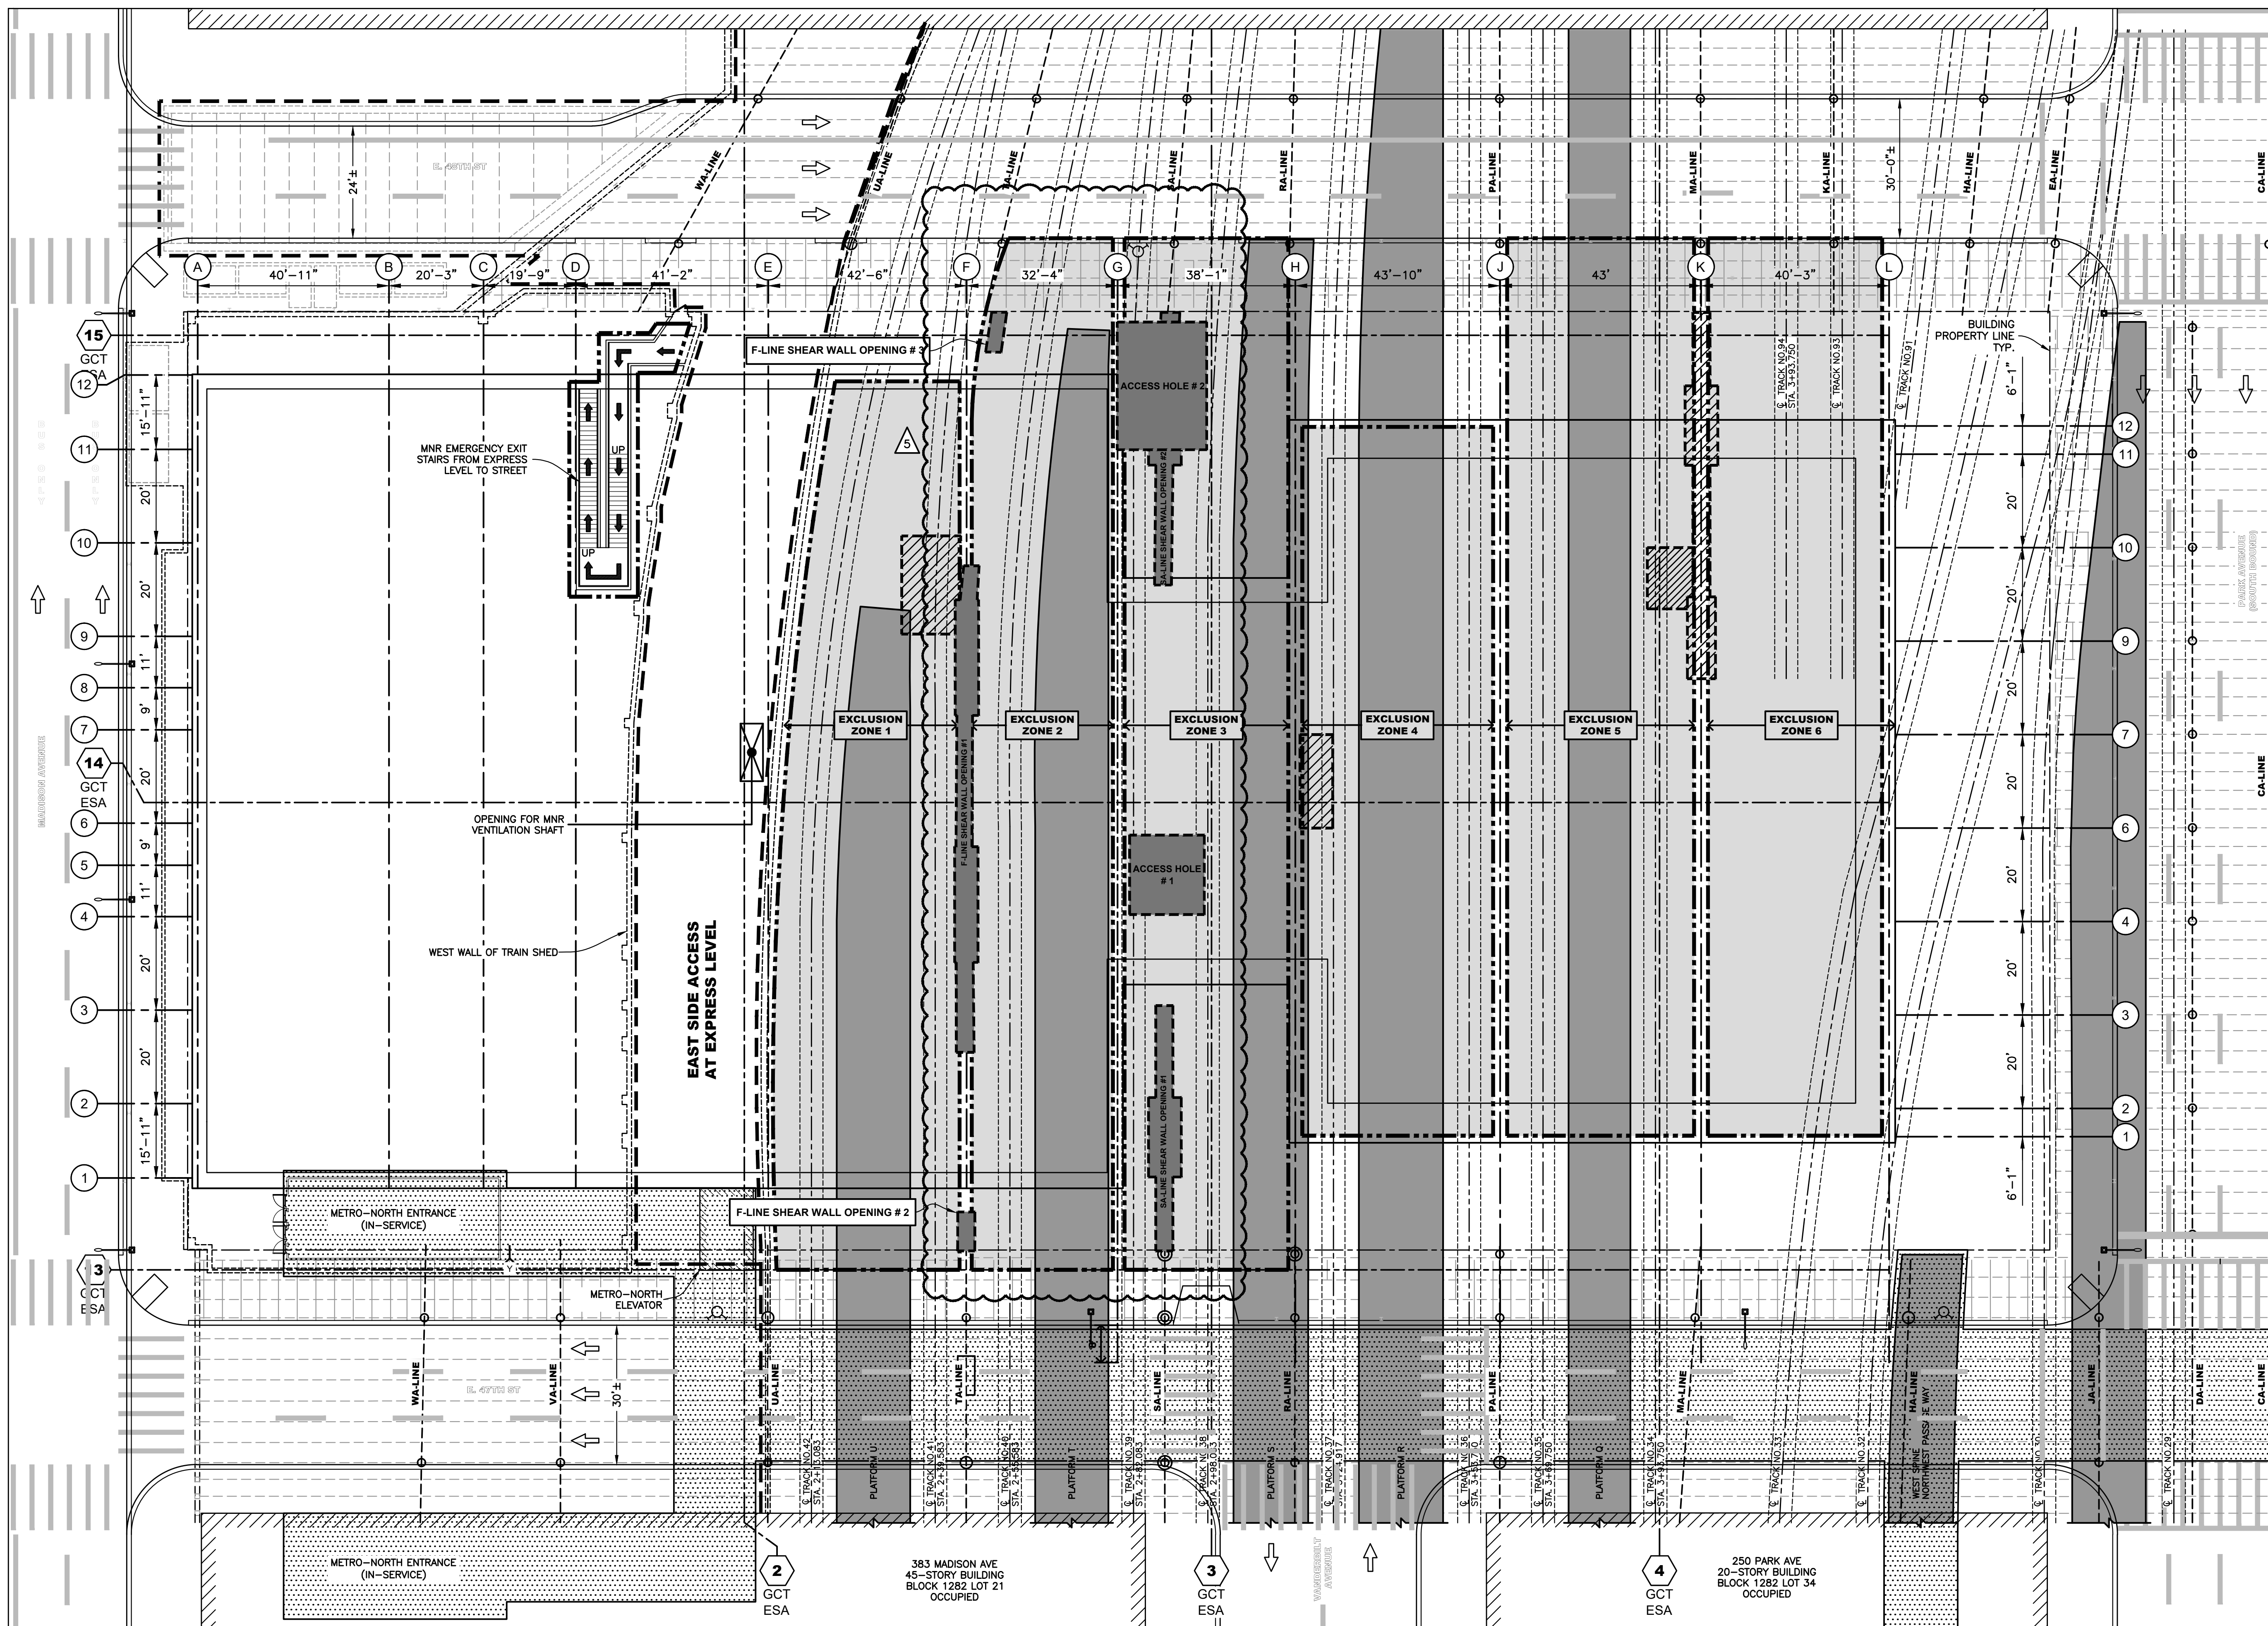
TITLE
 SAFETY ZONE PLAN
 GROUND FLOOR

SEAL & SIGNATURE
 Sk Ali-Shafin
APPROVED
 AMENDED PLAN
 03/12/2021
 CSC SSP

DRAWING BY: KC DATE: 03/04/2021
 PROJECT NO: 18211.03.00
 ENGINEER: JS
 SCALE: AS NOTED
 CHK BY: JS
 DWG NO: SSP-201.03

SAFETY ZONE PLAN - GROUND FLOOR
 Scale: 1" = 20'-0"

- NOTES:**
- THE EXISTING HIGHRISE TOWER IS UNDER FULL DEMOLITION BY A SEPARATE CONTRACTOR DURING THE SCOPE OF THE FOUNDATION CONTRACTOR'S WORK. SEE DM JOB NO. 123656640.
 SEE SHADED AREA WITH HEAVY BORDER FOR THE FOUNDATION CONTRACTOR'S WORK AREA AT THE GROUND FLOOR LEVEL.
 A MOBILE CRANE AT GRADE AND ACCESS HOLE TO SUB-CELLAR 3 WILL BE USED TO MOVE EQUIPMENT AND DEBRIS BETWEEN STREET LEVEL AND SUB-CELLAR 3. SEE CN 902/19.
 A MAGNI TELEHANDLER LOCATED ON THE 600 PSF PROTECTIVE PLATFORM SHALL BE LOCATED AT ACCESS HOLE #1 OR #2 TO LOAD THE JOB AND REMOVE DEBRIS.
 THE TOWER CRANE, HOIST LOADING DOCK, HEAVY-DUTY PLATFORM AND OTHER EQUIPMENT SHOWN OUTSIDE THE FOUNDATION CONTRACTOR'S WORK AREA ARE ASSOCIATED WITH THE DEMOLITION CONTRACTOR'S WORK. SEE DM-002 FOR ASSOCIATED PERMITS.
 - DAILY MEETINGS WILL BE HELD BETWEEN THE DEMOLITION AND FOUNDATION SUPERINTENDENTS TO ENSURE COORDINATION BETWEEN DEMOLITION, STEEL ERECTION, AND FOUNDATION WORK.
 - EGRESS
 - STAIR A AND STAIR B PROVIDE EGRESS FROM SUB-CELLAR 3 TO CELLAR. ACCESS AT GROUND FLOOR IS ELIMINATED BY THE NEW TRUCK PLATFORM AT GROUND FLOOR.
 EGRESS 1 : SCAFFOLD TOWER FROM CELLAR TO GROUND FLOOR.
 EGRESS 2 : STAIR "O" FROM SUB-CELLAR 2 TO GROUND FLOOR (PROVIDES ACCESS FROM SUB-CELLAR 1 AND CELLAR TO GROUND FLOOR, ALSO EMERGENCY EGRESS FOR MNR FROM EXPRESS LEVEL.




LEGEND	
	MNR TRAIN TRACK
	MNR TRAIN PLATFORM
	NEW OPENINGS TO BE MADE TYP.
	PREVIOUSLY CREATED OPENINGS TYP.
	CROSS PASSAGEWAY/ NORTHWEST PASSAGEWAY
	EAST SIDE ACCESS SPACE
	EXCLUSION ZONE
EXCLUSION ZONE 1	WHEN PERFORMING DEMOLITION BETWEEN GRIDLINES E & F, VACATE NORTHERN PORTION OF EAST SIDE ACCESS SPACE AS SHOWN IN PLAN. VACATE TRACKS 41 & 42 AND PLATFORM U.
EXCLUSION ZONE 2	WHEN PERFORMING DEMOLITION BETWEEN GRIDLINES F & G, VACATE TRACK 40 AND PLATFORM T.
EXCLUSION ZONE 3	WHEN PERFORMING DEMOLITION BETWEEN GRIDLINES G & H, VACATE TRACKS 39 & 38, AND PLATFORM S.
EXCLUSION ZONE 4	WHEN PERFORMING DEMOLITION BETWEEN GRIDLINES H & J, VACATE TRACKS 36 & 37, AND PLATFORM R.
EXCLUSION ZONE 5	WHEN PERFORMING DEMOLITION BETWEEN GRIDLINES J & K, VACATE TRACKS 34 & 35, AND PLATFORM Q.
EXCLUSION ZONE 6	WHEN PERFORMING DEMOLITION BETWEEN GRIDLINES J & L, VACATE TRACKS 34 & 34, AND ASSOCIATED MAINTENANCE YARD.
NOTE: 1. ALL WORK REQUIRING EXCLUSION ZONES SHALL BE PERFORMED DURING WEEKNIGHTS AND WEEKENDS.	

5	03/04/21	ADD NEW GROUND FLOOR OPENINGS, REVISED LEGEND.	KG
No.	DATE	DESCRIPTION	BY
HOWARD I. SHAPIRO & ASSOCIATES CONSULTING ENGINEERS, P.C.			
266 MERRICK ROAD, SUITE 500, LYNBROOK, N.Y. 11563 TEL: (516) 791-2600 FAX: (516) 791-5425			
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CLIENT JOHN CIVETTA & SONS, INC. 1123 BRONX RIVER AVE, BRONX, NY 10472 PH: (718) 589-9000			
PROJECT SITE SAFETY FOR FOUNDATION ENHANCEMENTS AT 270 PARK AVENUE, MANHATTAN, NY			
ZONING INFORMATION BLOCK: 1283 LOT: 21 ZONE: C5-3 ZONING MAP: 8D COMMUNITY BOARD: 105 BIN #: 1035421			
PLACE STICKER HERE		EXAMINER'S STAMP HERE	

PLAN VIEW - BELOW GRADE: EXCLUSION ZONES FOR GROUND FLOOR OPENINGS.
Scale: N.T.S.

TITLE GROUND FLOOR OPENINGS BELOW GRADE EXCLUSION ZONE PLAN		
SEAL & SIGNATURE APPROVED AMENDED PLAN 03/12/2021 CSC SSP	DRAWING BY: KC PROJECT NO: 18211.05.00 ENGINEER: JS SCALE: AS NOTED CHK BY: JS DWG NO:	DATE: 03/04/2021 DATE: 18211.05.00 SCALE: AS NOTED DATE: 03/12/2021 DATE: 03/12/2021
SSP-309.01		32 OF 47

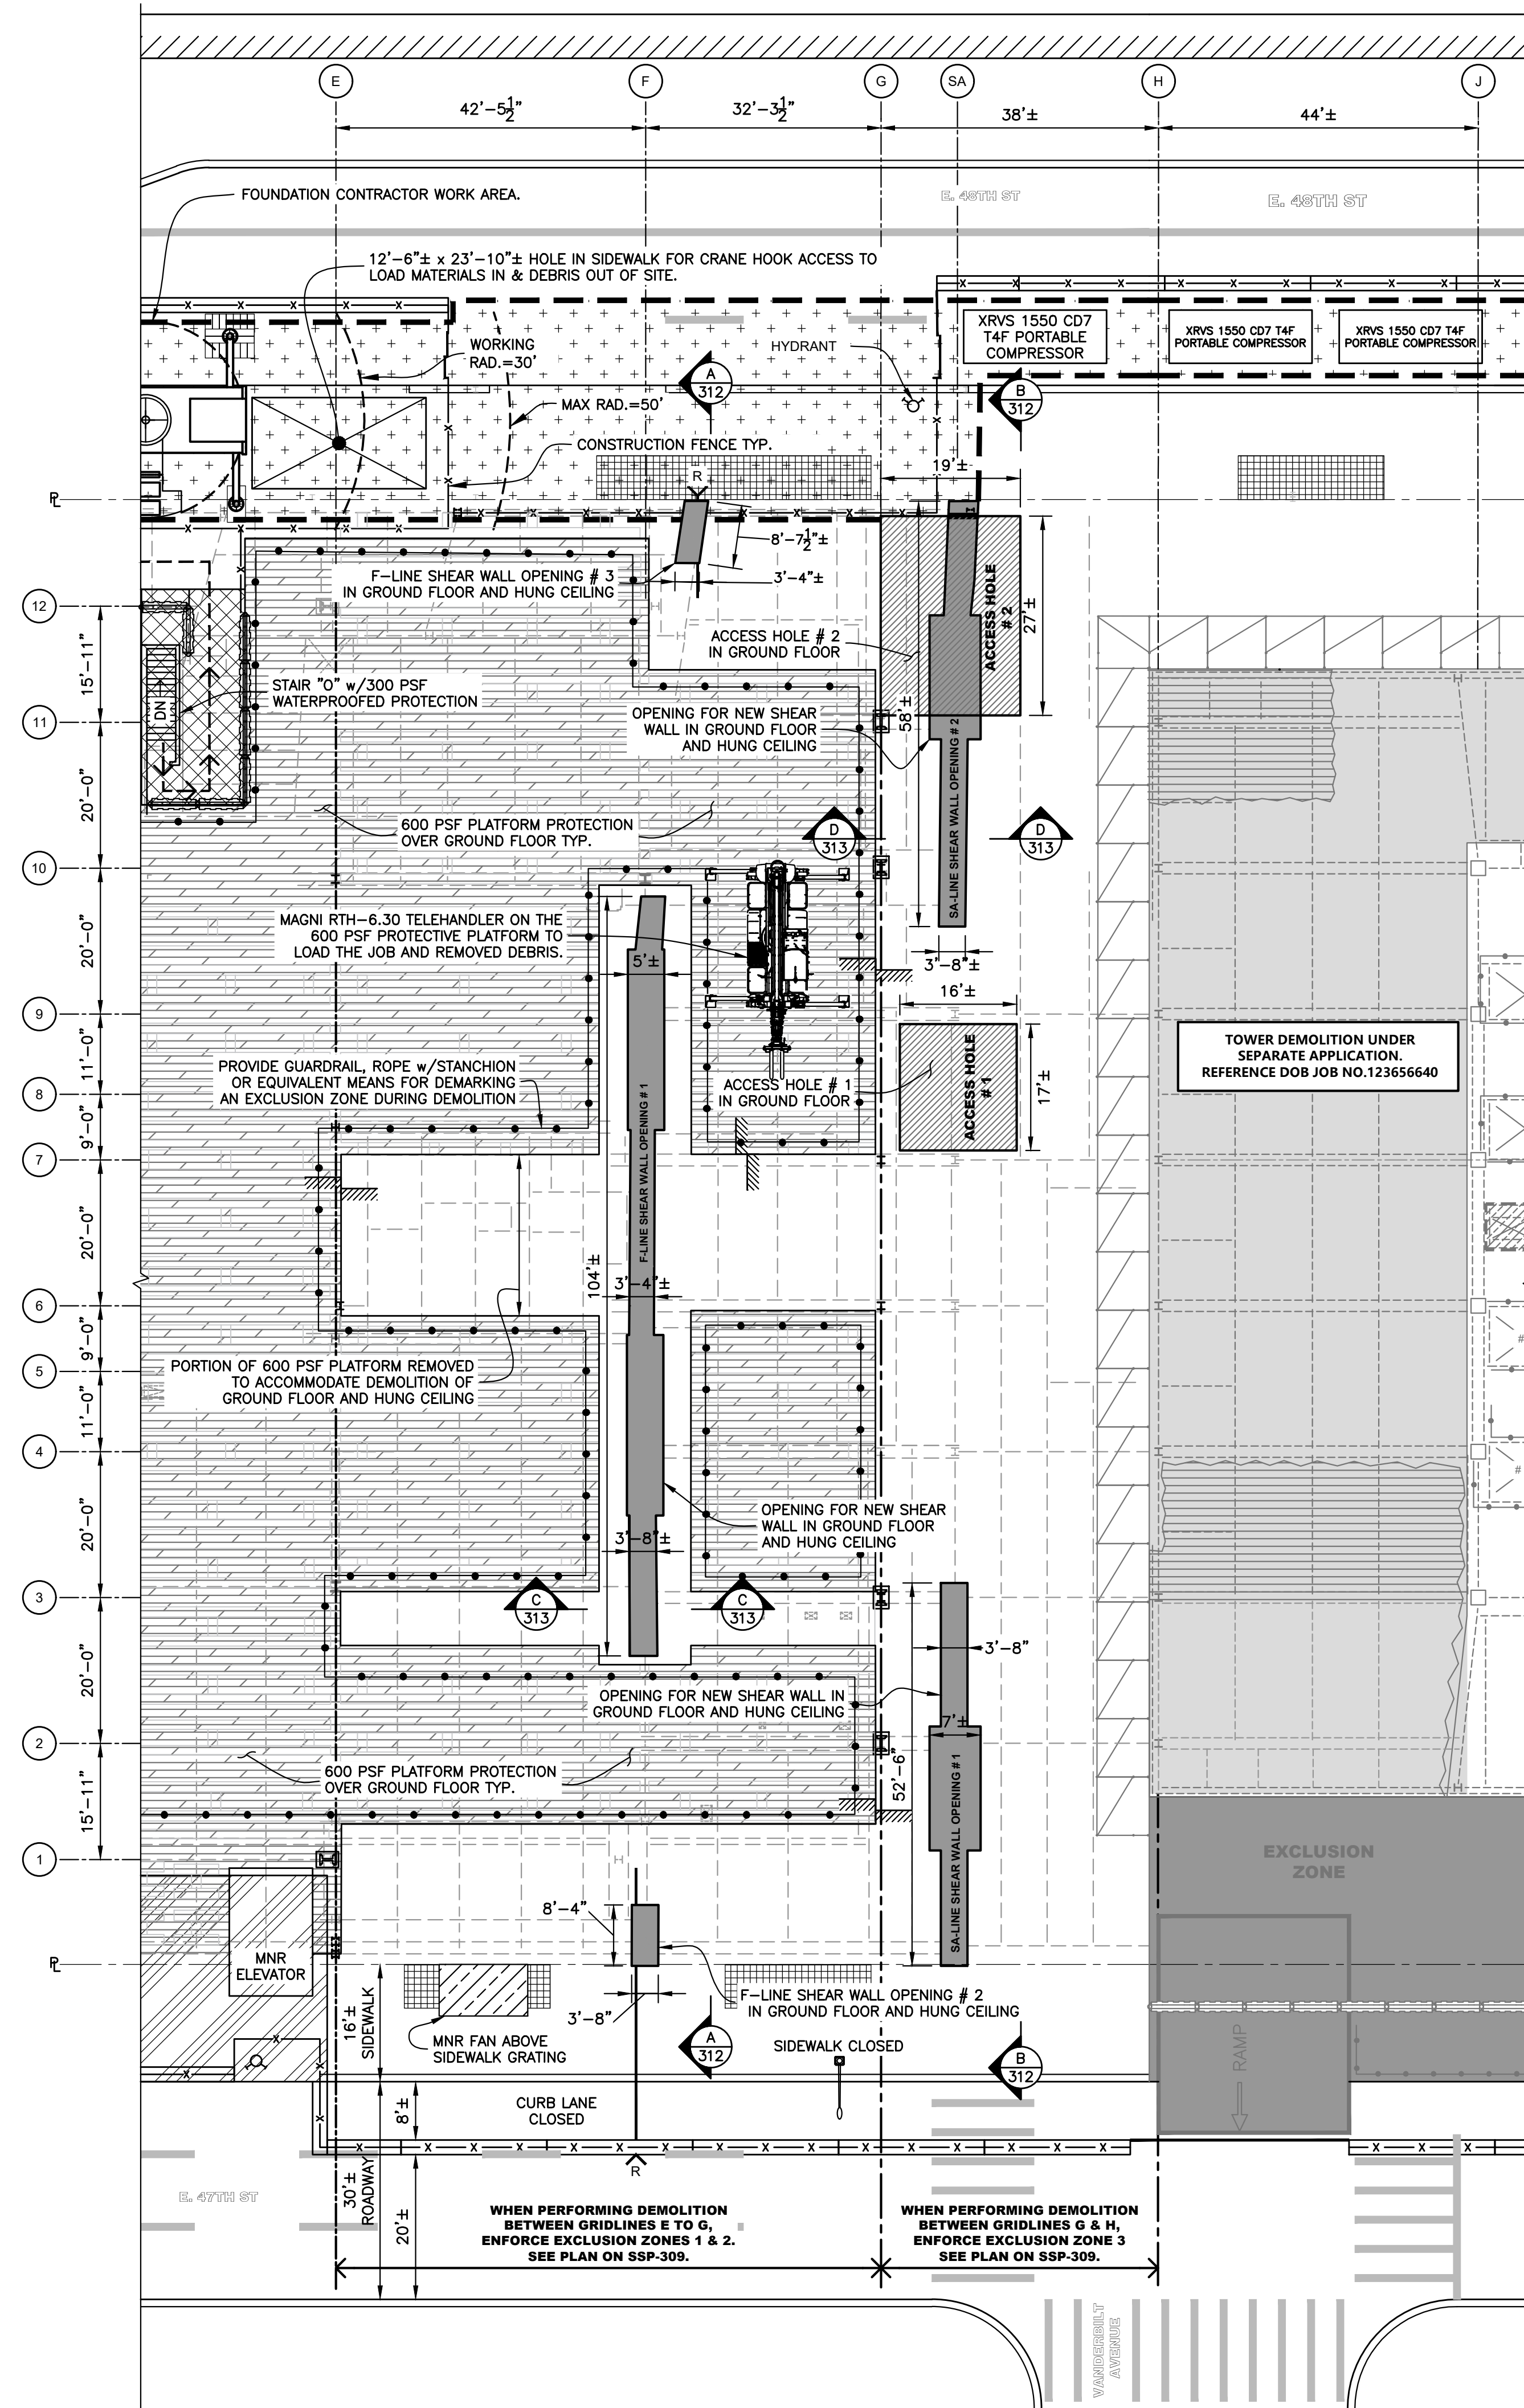


LEGEND	
	NEW SHEAR WALL OPENINGS IN GROUND FL. & HUNG CEILING
	NEW ACCESS OPENING IN GROUND FL.
	FOUNDATION CONTRACTOR WORK AREA TYP.
	600 PSF PLATFORM PROTECTION OVER GROUND FLOOR TYP.
	8' HIGH SIDEWALK SHED TYP.
	STANDARD GUARDRAIL TYP.
	SCAFFOLD w/ GUARDRAIL & DEBRIS NETTING TYP.
	CONCRETE JERSEY BARRIER TYP.
	YODOCKS TYP.

SEQUENCE 1:

- FOR F-LINE OPENINGS, REMOVE PORTIONS OF THE 600 PSF PLATFORM PROTECTION OVER THE GROUND FLOOR TO ACCESS THE GROUND FLOOR.
- INSTALL SHORING TO SUPPORT GROUND FLOOR SLAB.
- PRIOR TO COMMENCING DEMOLITION, ENFORCE EXCLUSION ZONES AT THE WORK AREA AND AN ADDITIONAL 20' IN ALL DIRECTIONS SURROUNDING THE WORK AREA AT THE WORKING LEVEL AND AT THE MNR EXPRESS LEVEL. SEE SSP-309 AND SSP-315 FOR BELOW GRADE EXCLUSION ZONES.
PROVIDE STANDARD GUARDRAIL, YODOCKS, ROPE w/ STANCHION OR EQUIVALENT TO DEMARK EXCLUSION ZONE.
- PROVIDE PROTECTION OVER THE HUNG CEILING FOR FALLING DEBRIS WHEN CHOPPING THE GROUND FLOOR SLAB. SEE "HUNG CEILING PROTECTION DETAIL" ON SSP-317.
- SCORE OR SAWCUT SLAB EDGE AROUND OPENING.
- DEMOLISH PORTION OF GROUND FLOOR SLAB AS SHOWN IN PLAN WITH MECHANICAL DEMOLITION EQUIPMENT OR BY HAND. MECHANICAL DEMOLITION EQUIPMENT TO MAINTAIN A MINIMUM OF 3' EDGE DISTANCE BETWEEN EDGE OF BLADE OR TRACK AND WORKING FACE DURING SLAB DEMOLITION.
IF SLAB IS CHOPPED BY HAND, MEN SHALL STAND ON PLANKS SPANNING FROM BEAM-TO-BEAM. SEE "CHOPPING CONCRETE SLAB BY HAND DETAIL" ON SSP-317.


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CLIENT JOHN CIVETTA & SONS, INC. 1123 BRONX RIVER AVE, BRONX, NY 10472 PH: (718) 589-9000			
PROJECT PARTIAL DEMOLITION OF CELLAR SLABS FOR FOUNDATION CONSTRUCTION AT 270 PARK AVENUE, MANHATTAN, NY			
ZONING INFORMATION BLOCK: 1283 LOT: 21 ZONE: C5-3 ZONING MAP: 8D COMMUNITY BOARD: 105 BIN #: 1035421			
PLACE STICKER HERE		EXAMINER'S STAMP HERE	
TITLE FLOOR OPENINGS GROUND FLOOR PARTIAL PLAN			
SEAL & SIGNATURE APPROVED AMENDED PLAN 03/12/2021 CSC SSP	DRAWING BY: KC PROJECT NO: 18211.03.00 ENGINEER: JS SCALE: AS NOTED CHK BY: JS DWG NO:	DATE: 03/04/2021 SSP-311.00	

GROUND FLOOR PARTIAL PLAN
Scale: 1"= 15'-0"

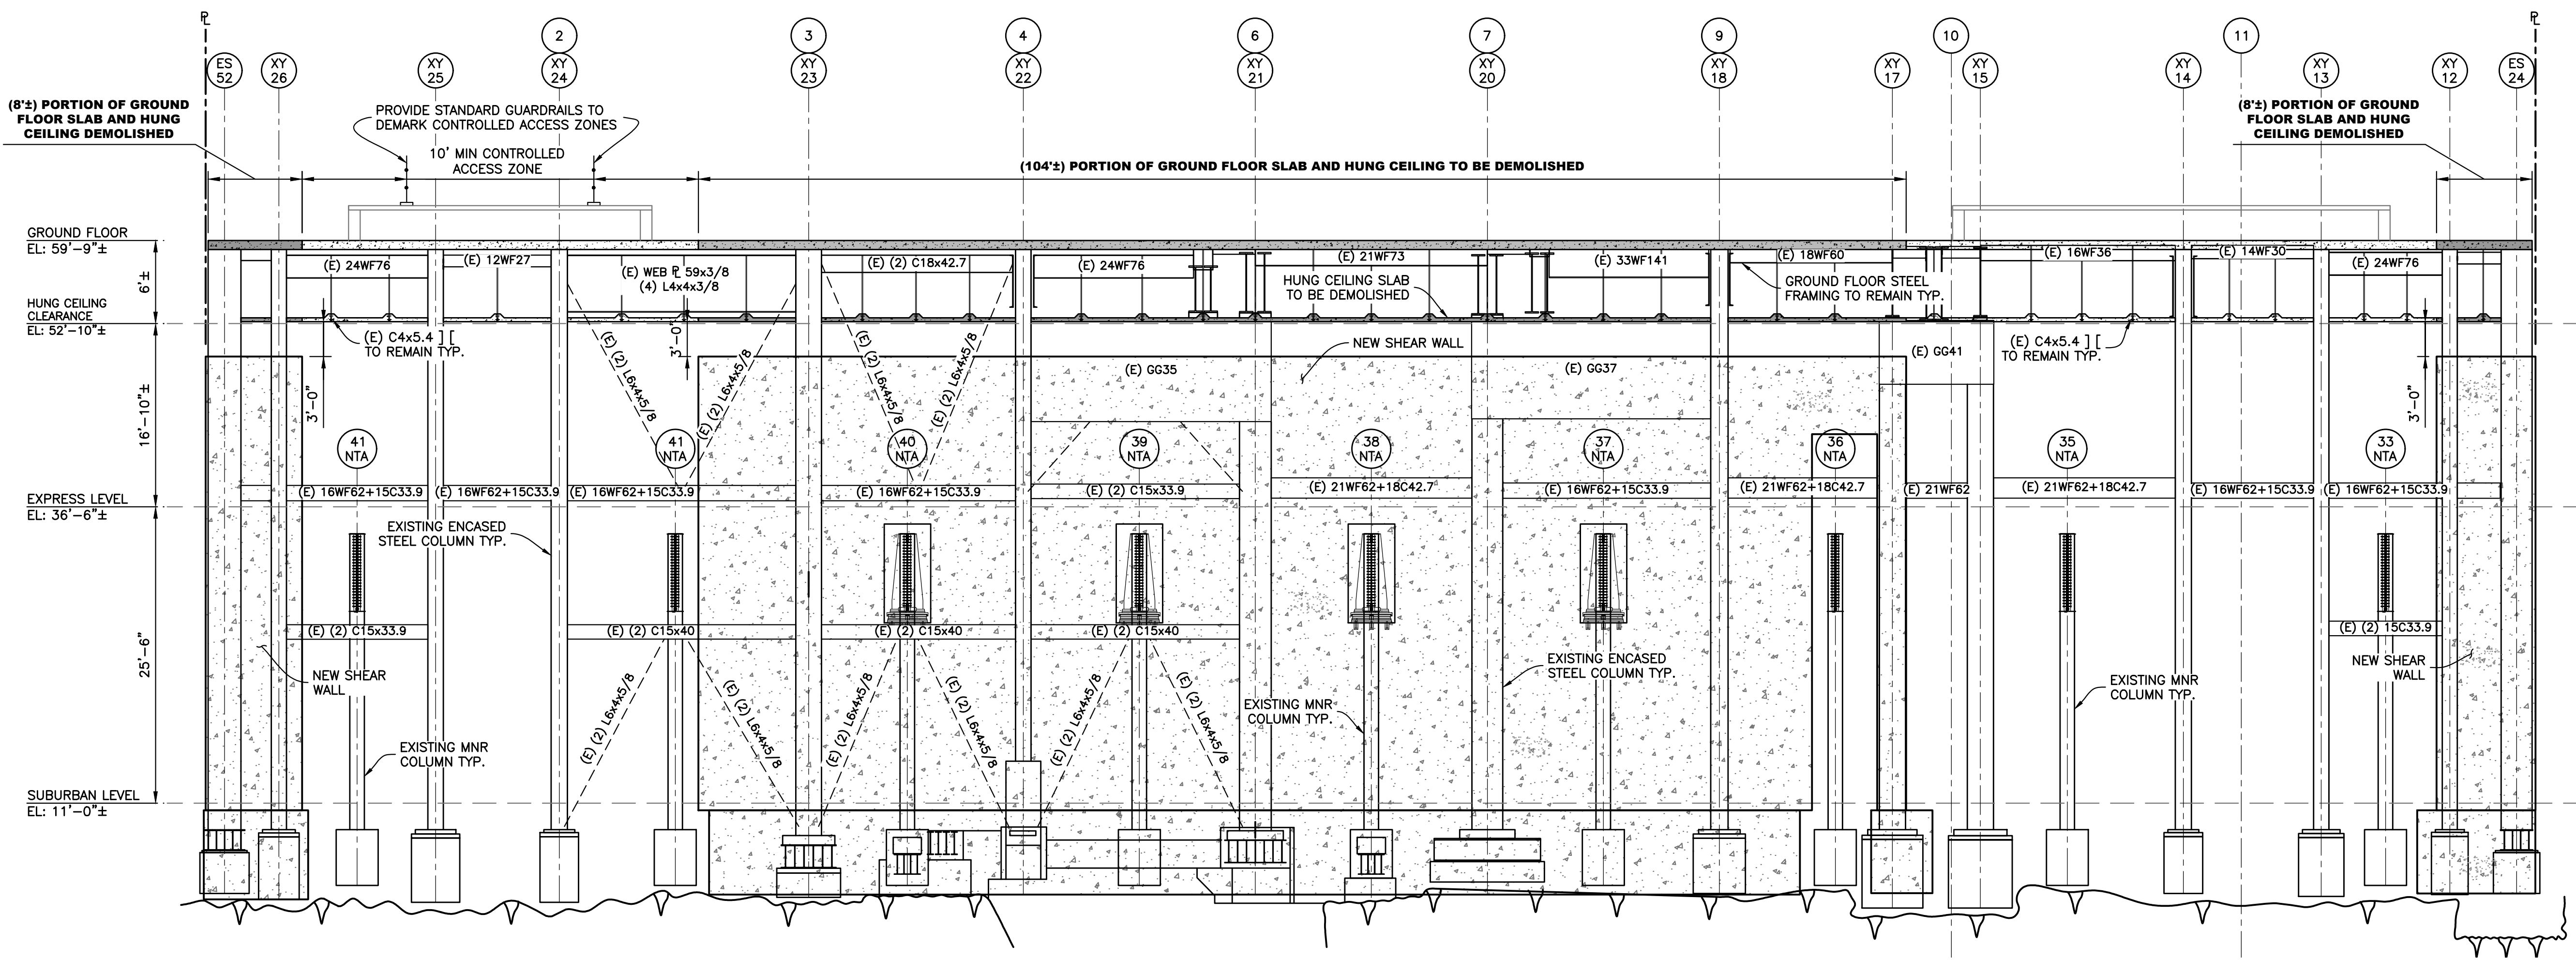


SECTION A-A: F-LINE SHEAR WALL
Scale: 1/8" = 1'-0"

- NOTES:
1. THE GROUND FLOOR SLAB CAN BE CHOPPED BY MECHANICAL MEANS OR HAND METHODS.
 2. THE HUNG CEILING SHALL BE CHOPPED BY HAND METHODS ONLY.
 3. EXISTING STEEL AT THE GROUND FLOOR AND HUNG CEILING SHALL REMAIN IN PLACE.

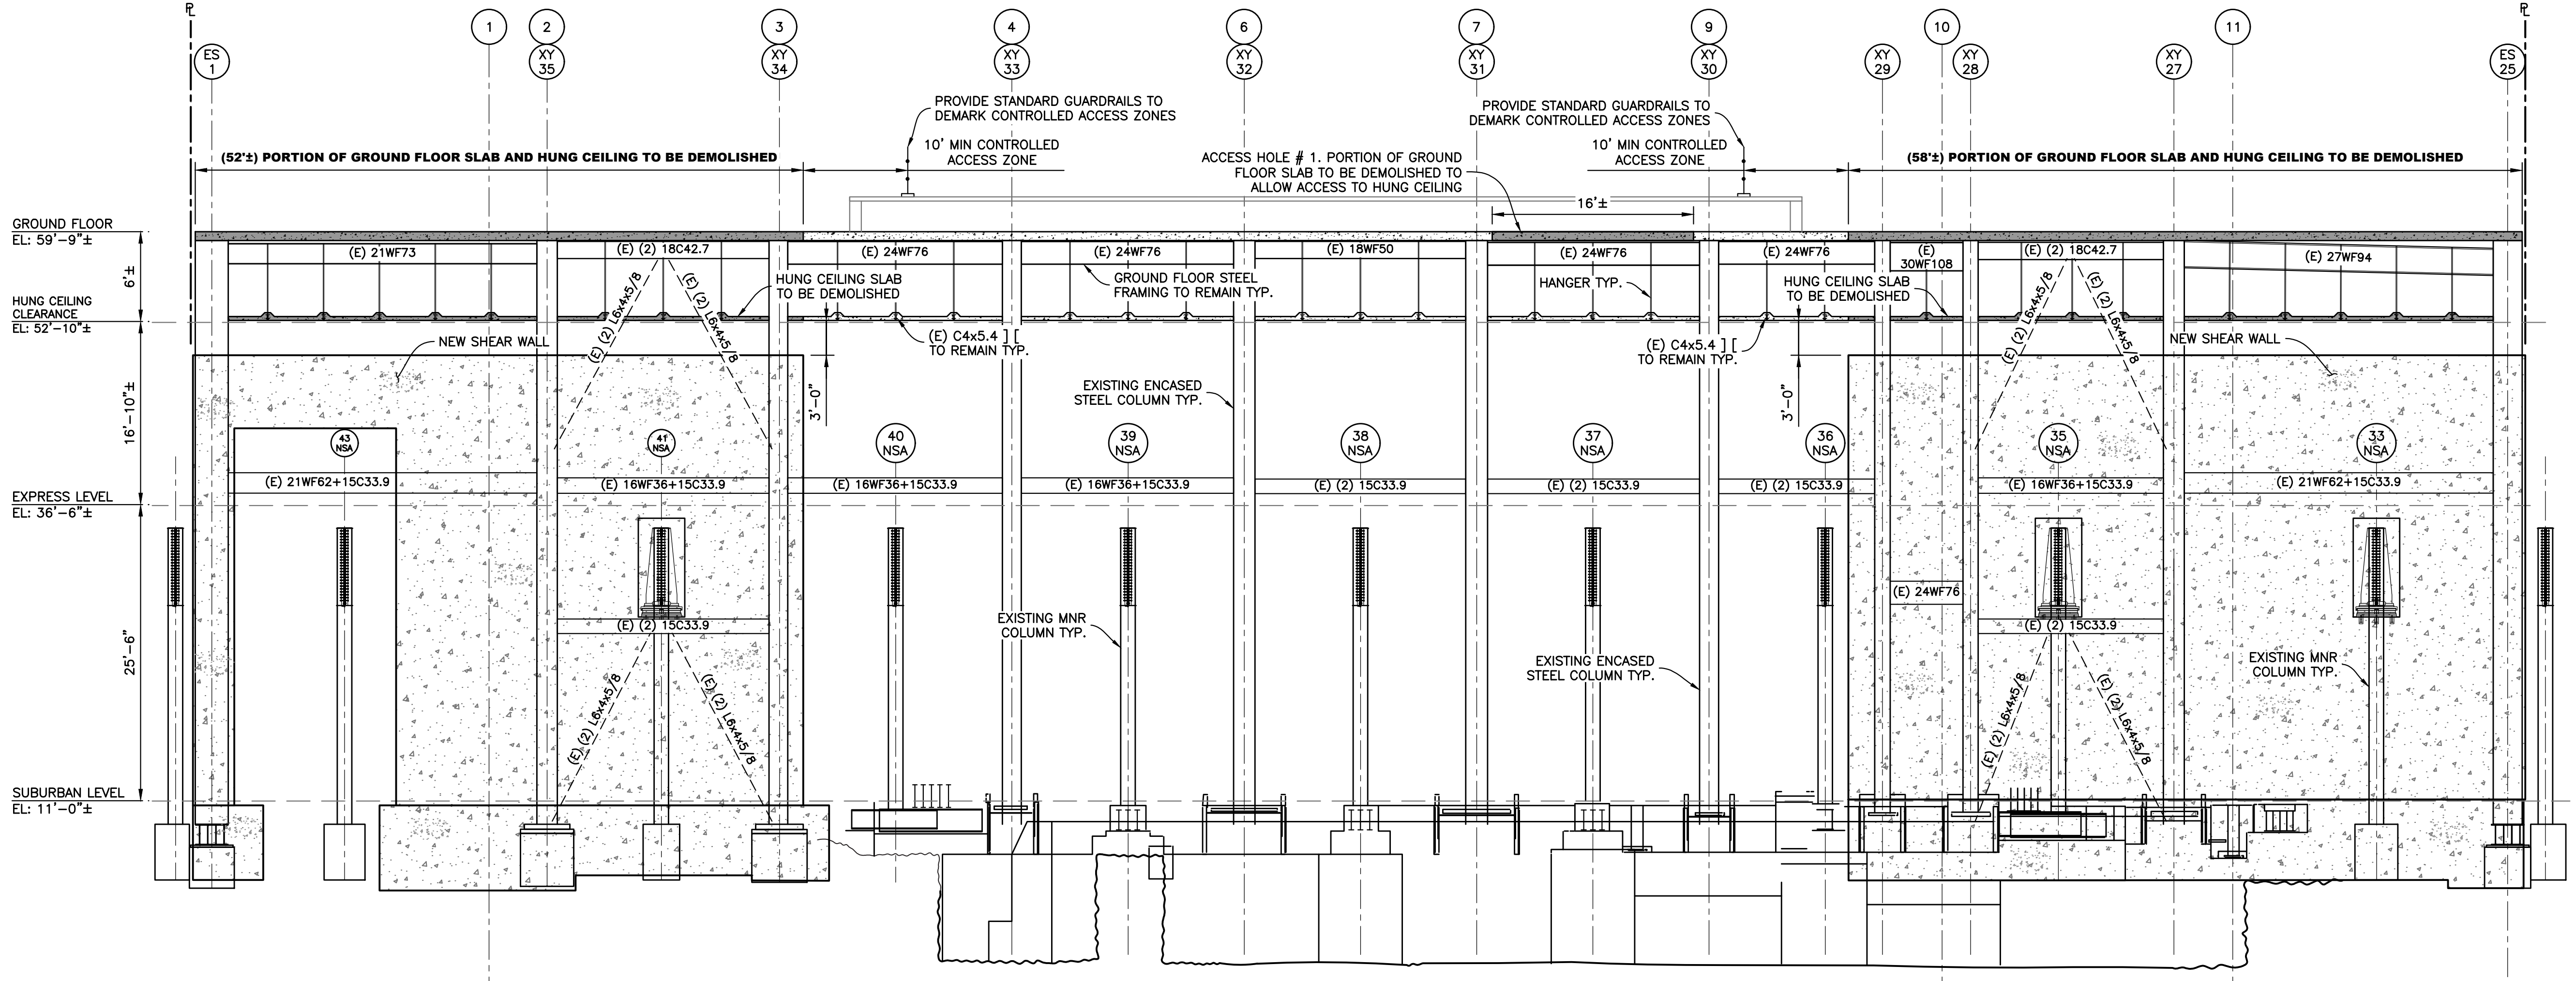


SECTION B-B: SA-LINE SHEAR WALL
Scale: 1/8" = 1'-0"

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PROJECT PARTIAL DEMOLITION OF CELLAR SLABS FOR FOUNDATION CONSTRUCTION AT 270 PARK AVENUE, MANHATTAN, NY			
ZONING INFORMATION BLOCK: 1283 LOT: 21 ZONE: C5-3 ZONING MAP: 8D COMMUNITY BOARD: 105 BIN #: 1035421			
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TITLE FLOOR OPENINGS SECTIONS A-A & B-B			
SEAL & SIGNATURE Sk Ali-Shafiq APPROVED AMENDED PLAN 03/12/2021 CSC SSP		DRAWING BY: KC DATE: 03/04/2021 PROJECT NO: 18211.03.00 ENGINEER: JS SCALE: AS NOTED CHK BY: JS DWG NO:	
		SSP-312.00	
		34 OF 44	

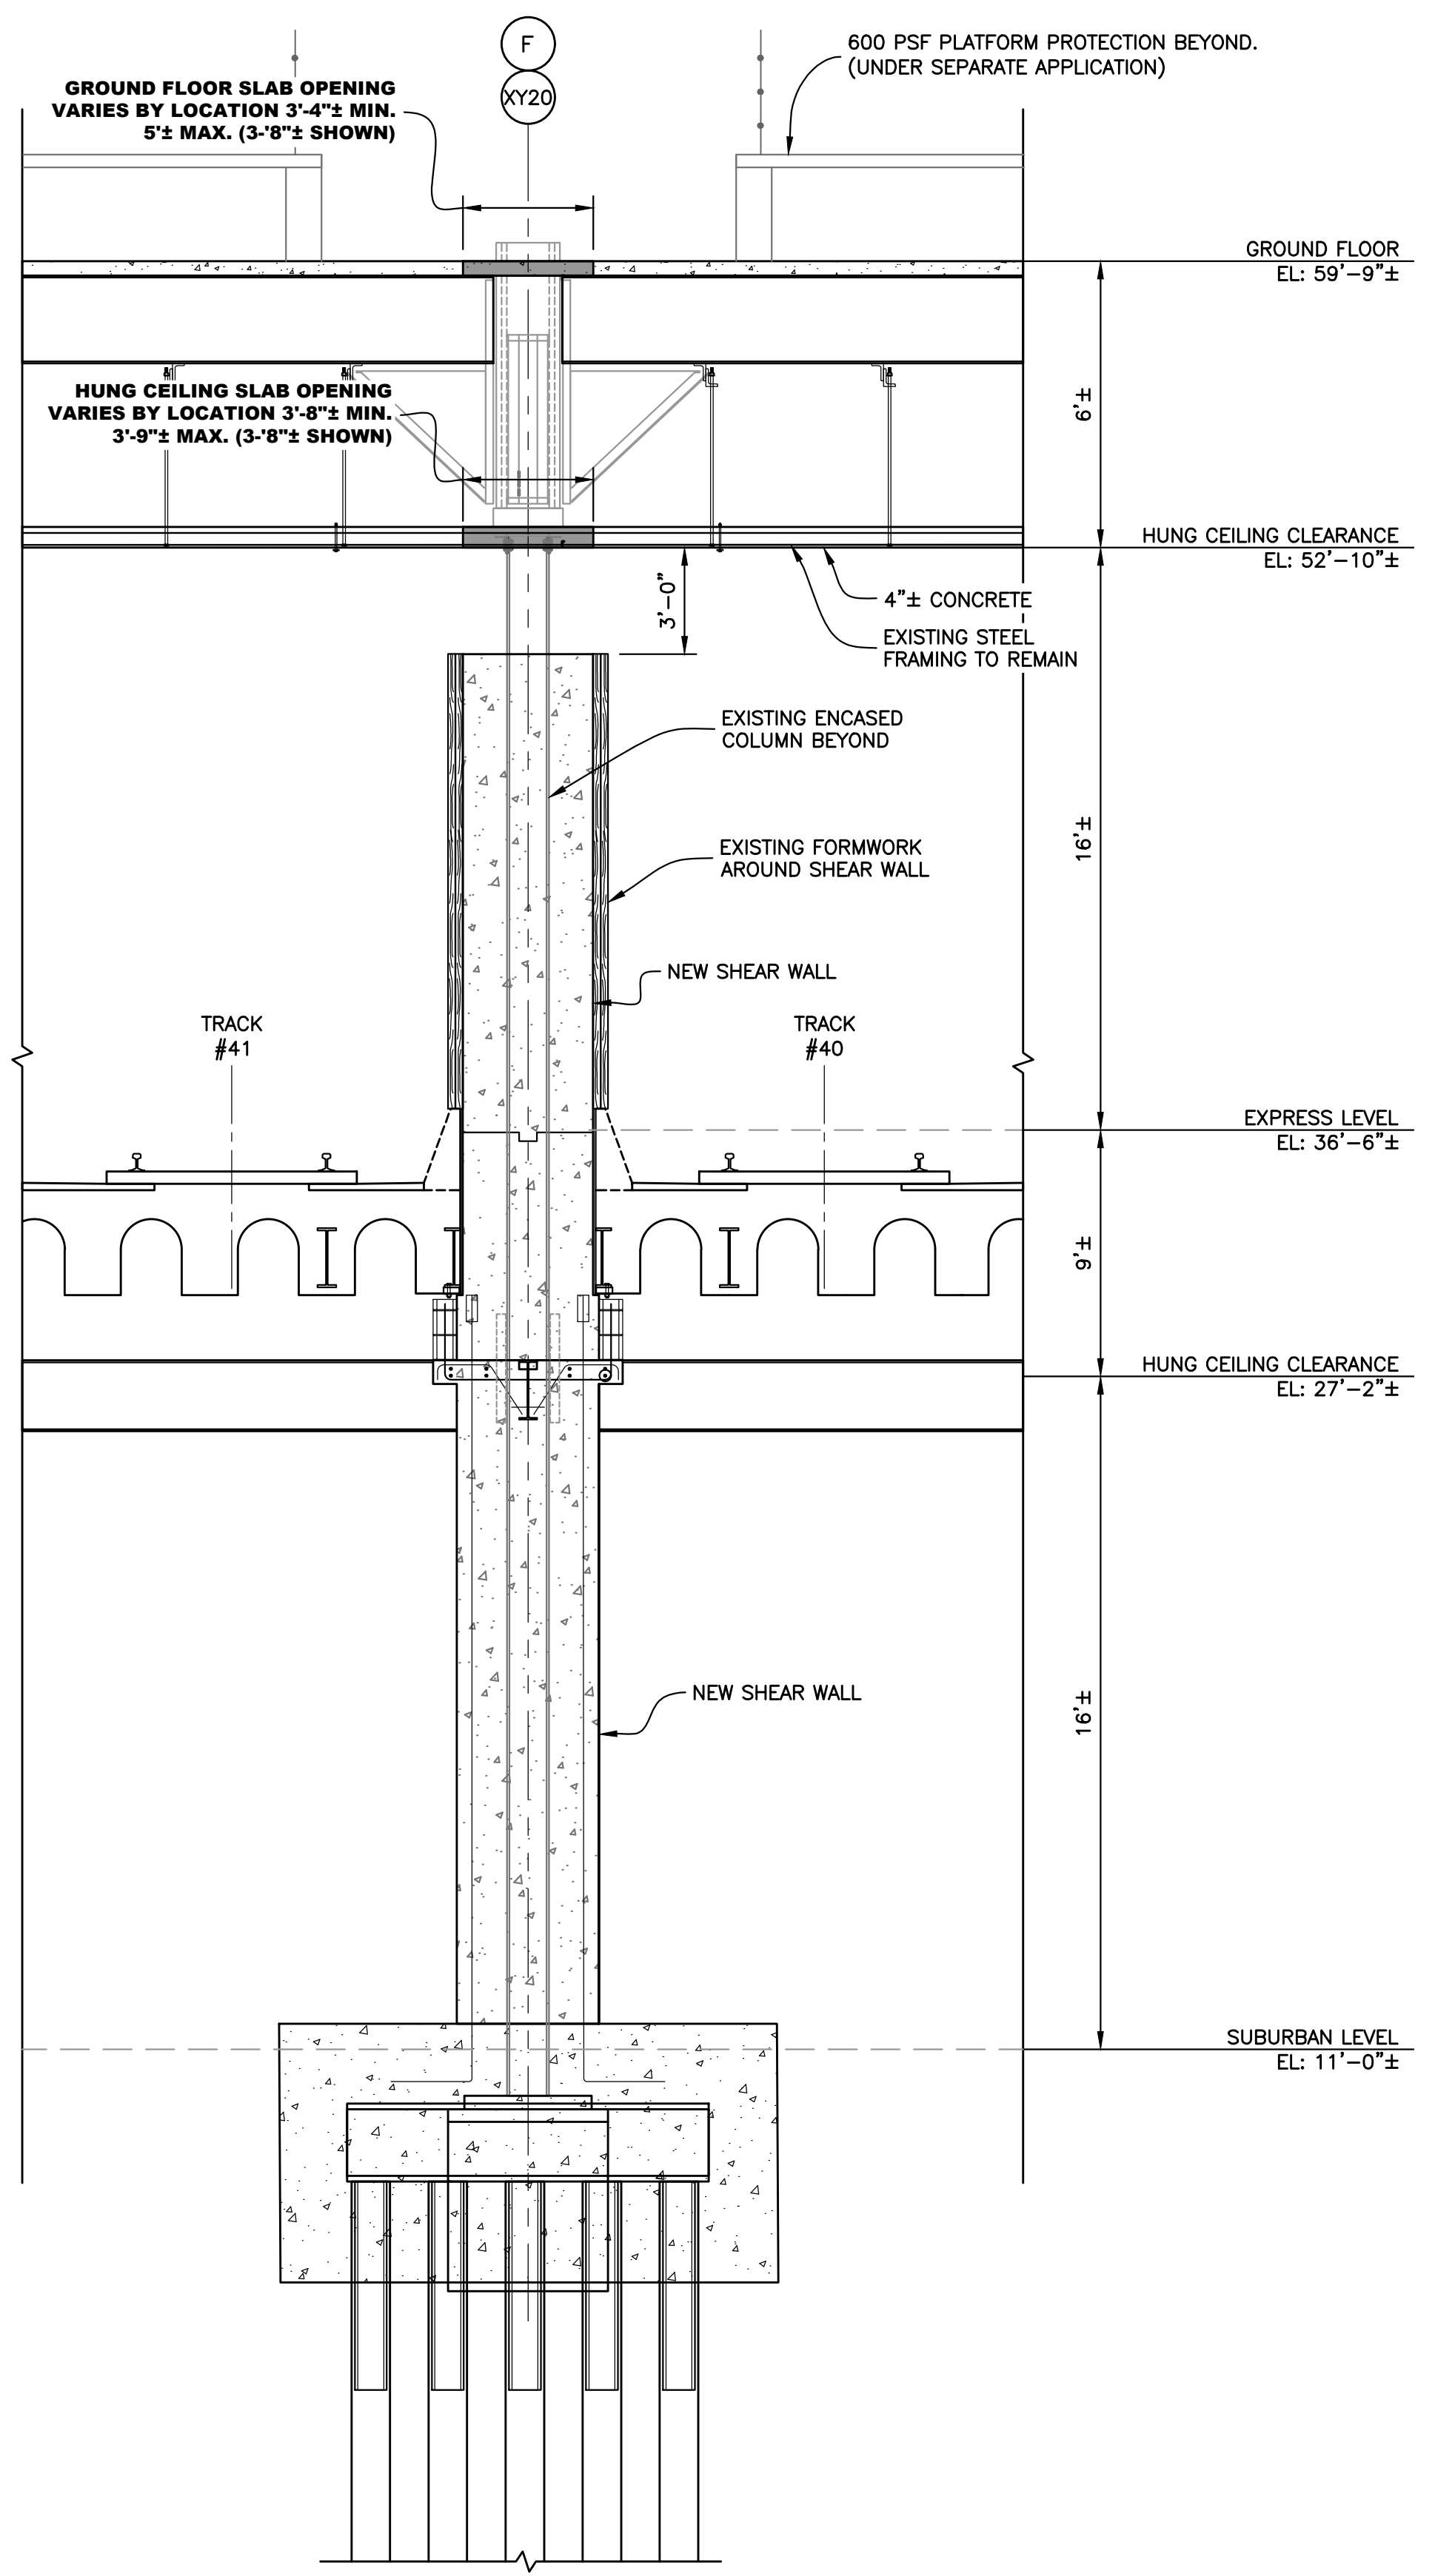


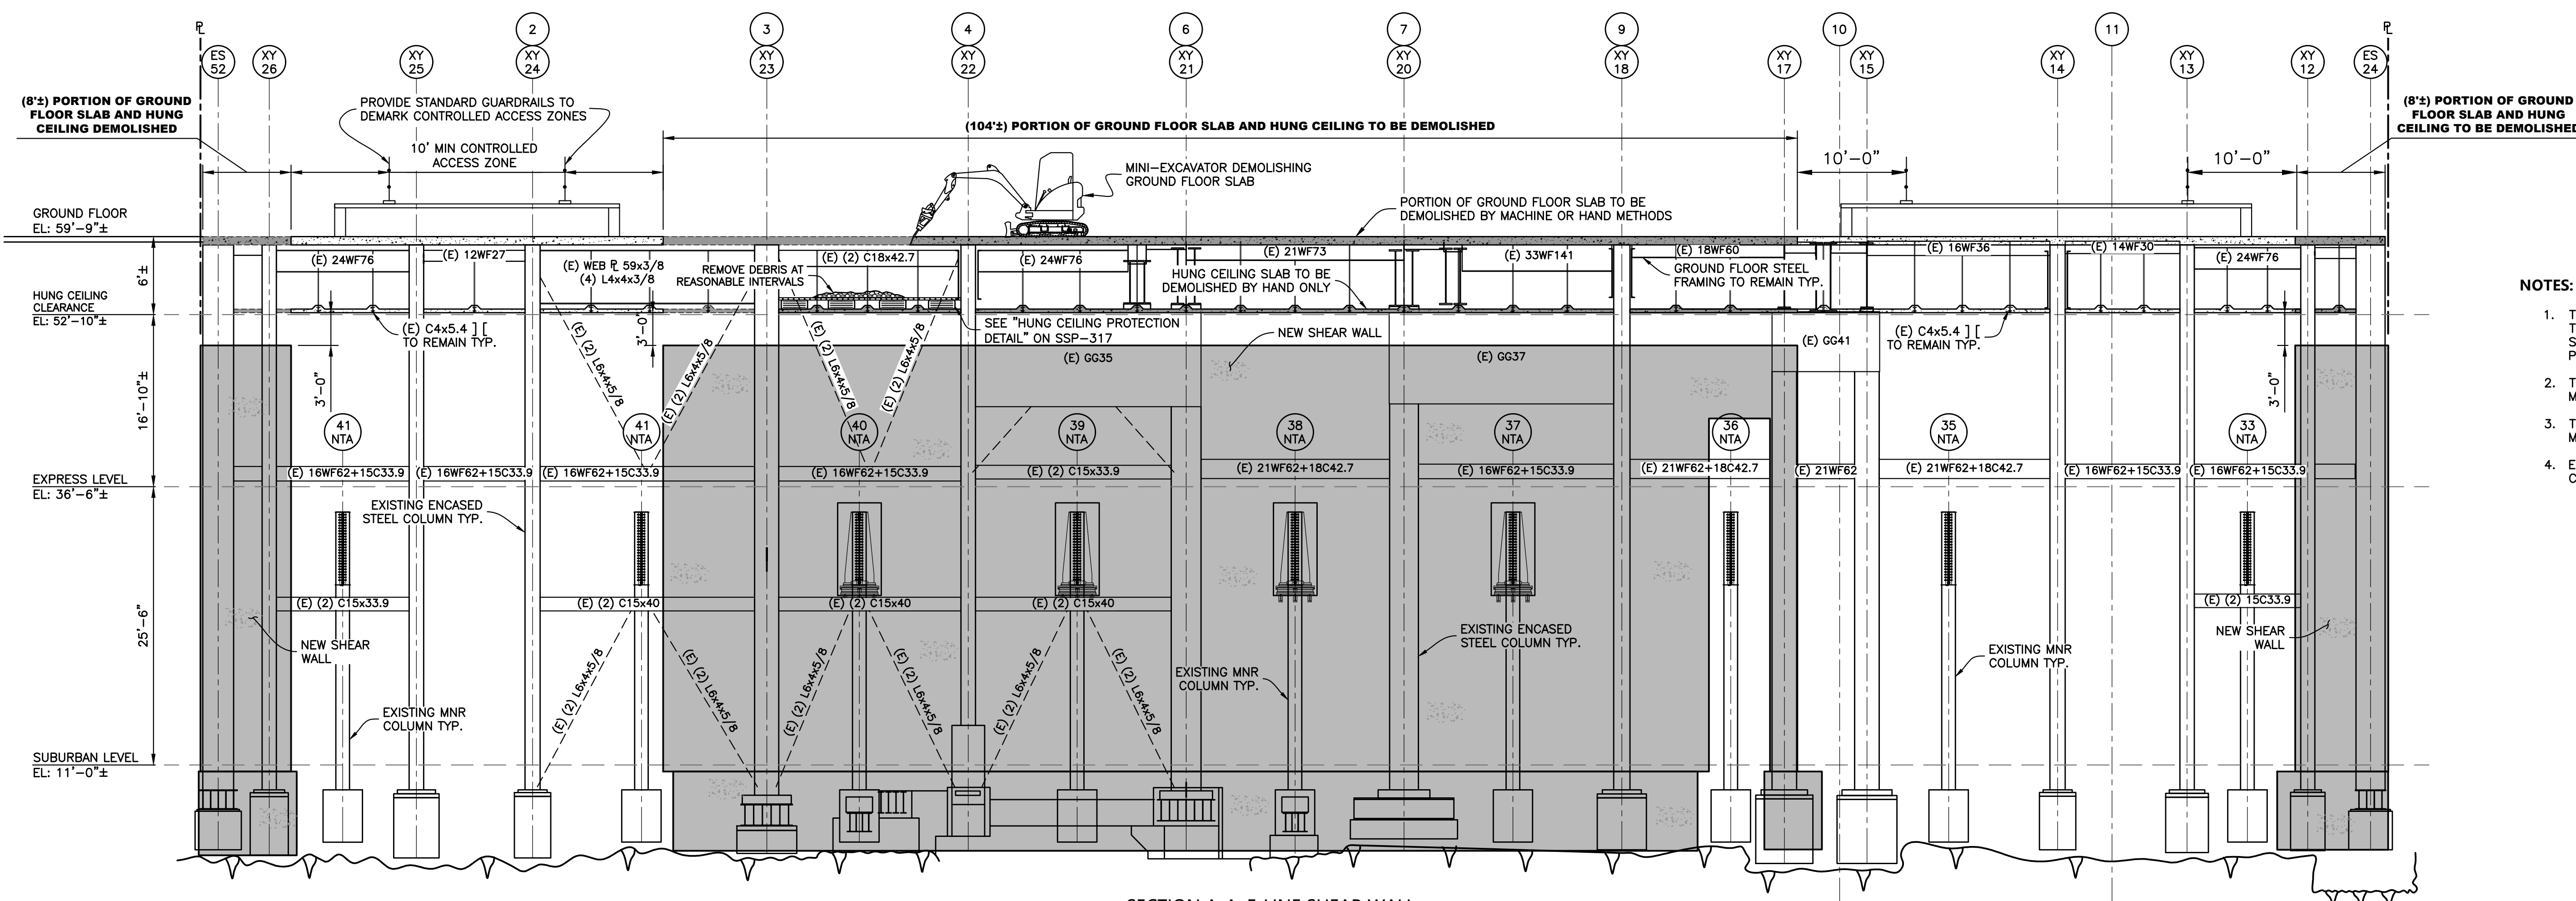
SECTION C-C: F-LINE SHEAR WALL
Scale: 1/4" = 1'-0"

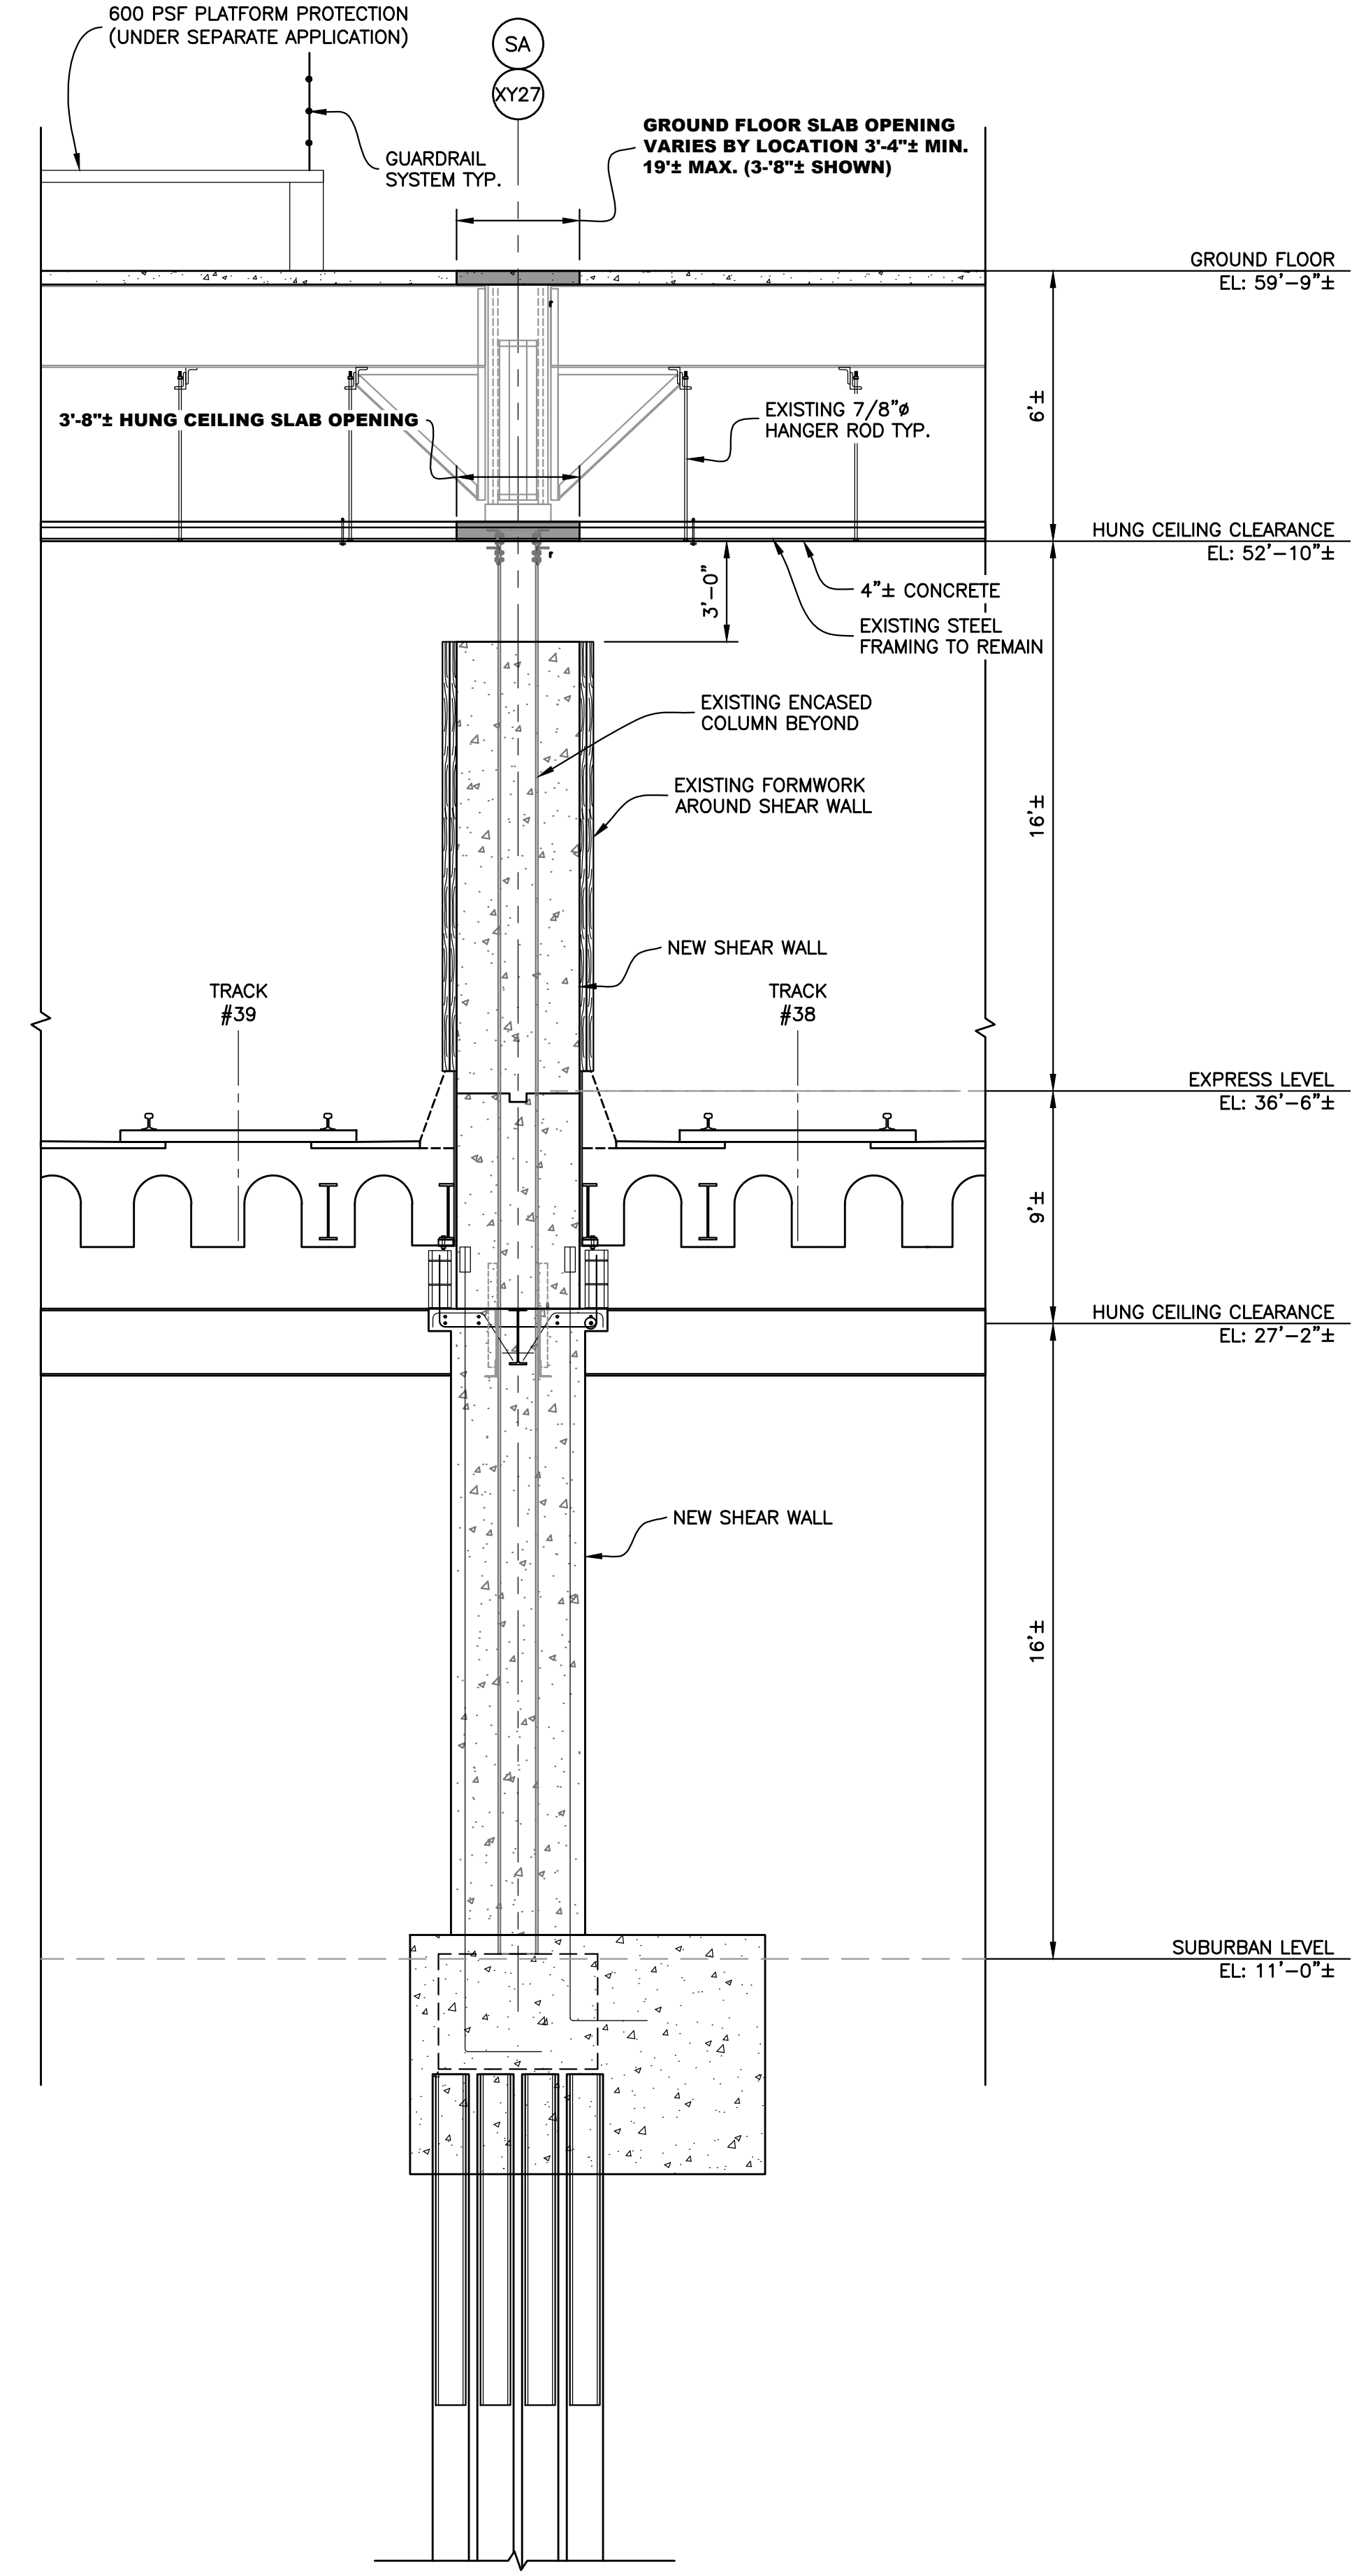

SECTION D-D: SA-LINE SHEAR WALL
Scale: 1/4" = 1'-0"


- NOTES:**
1. THE GROUND FLOOR SLAB CAN BE CHOPPED BY MECHANICAL MEANS OR HAND METHODS.
 2. THE HUNG CEILING SHALL BE CHOPPED BY HAND METHODS ONLY.
 3. EXISTING STEEL AT THE GROUND FLOOR AND HUNG CEILING SHALL REMAIN IN PLACE.

No.	DATE	DESCRIPTION	BY
HOWARD I. SHAPIRO & ASSOCIATES CONSULTING ENGINEERS, P.C.			
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CLIENT JOHN CIVETTA & SONS, INC. 1123 BRONX RIVER AVE, BRONX, NY 10472 PH: (718) 589-9000			
PROJECT PARTIAL DEMOLITION OF CELLAR SLABS FOR FOUNDATION CONSTRUCTION AT 270 PARK AVENUE, MANHATTAN, NY			
ZONING INFORMATION BLOCK: 1283 LOT: 21 ZONE: C5-3 ZONING MAP: 8D COMMUNITY BOARD: 105 BIN #: 1035421			
PLACE STICKER HERE		EXAMINER'S STAMP HERE	
TITLE FLOOR OPENINGS SECTIONS C-C & D-D			
<small>SEAL & SIGNATURE</small>  APPROVED AMENDED PLAN 03/12/2021 CSC SSP		DRAWING BY: KC DATE: 03/04/2021 PROJECT NO: 18211.03.00 ENGINEER: JS SCALE: AS NOTED CHK BY: JS DWG NO:	
		SSP-313.00	




SECTION A-A: F-LINE SHEAR WALL
Scale: 1/8" = 1'-0"

- NOTES:**
1. THE PURPOSE OF SCORING THE SLAB IS TO PRESERVE THE WIRE MESH REINFORCING STEEL AND TO ATTAIN A STRAIGHT NEAT EDGE OF SLAB. AFTER THE SLAB PERIMETER IS SCORED, THE SLAB CAN BE CHOPPED.
 2. THE GROUND FLOOR SLAB CAN BE CHOPPED BY MECHANICAL MEANS OR HAND METHODS.
 3. THE HUNG CEILING SHALL BE CHOPPED BY HAND METHODS ONLY.
 4. EXISTING STEEL AT THE GROUND FLOOR AND HUNG CEILING SHALL REMAIN IN PLACE.

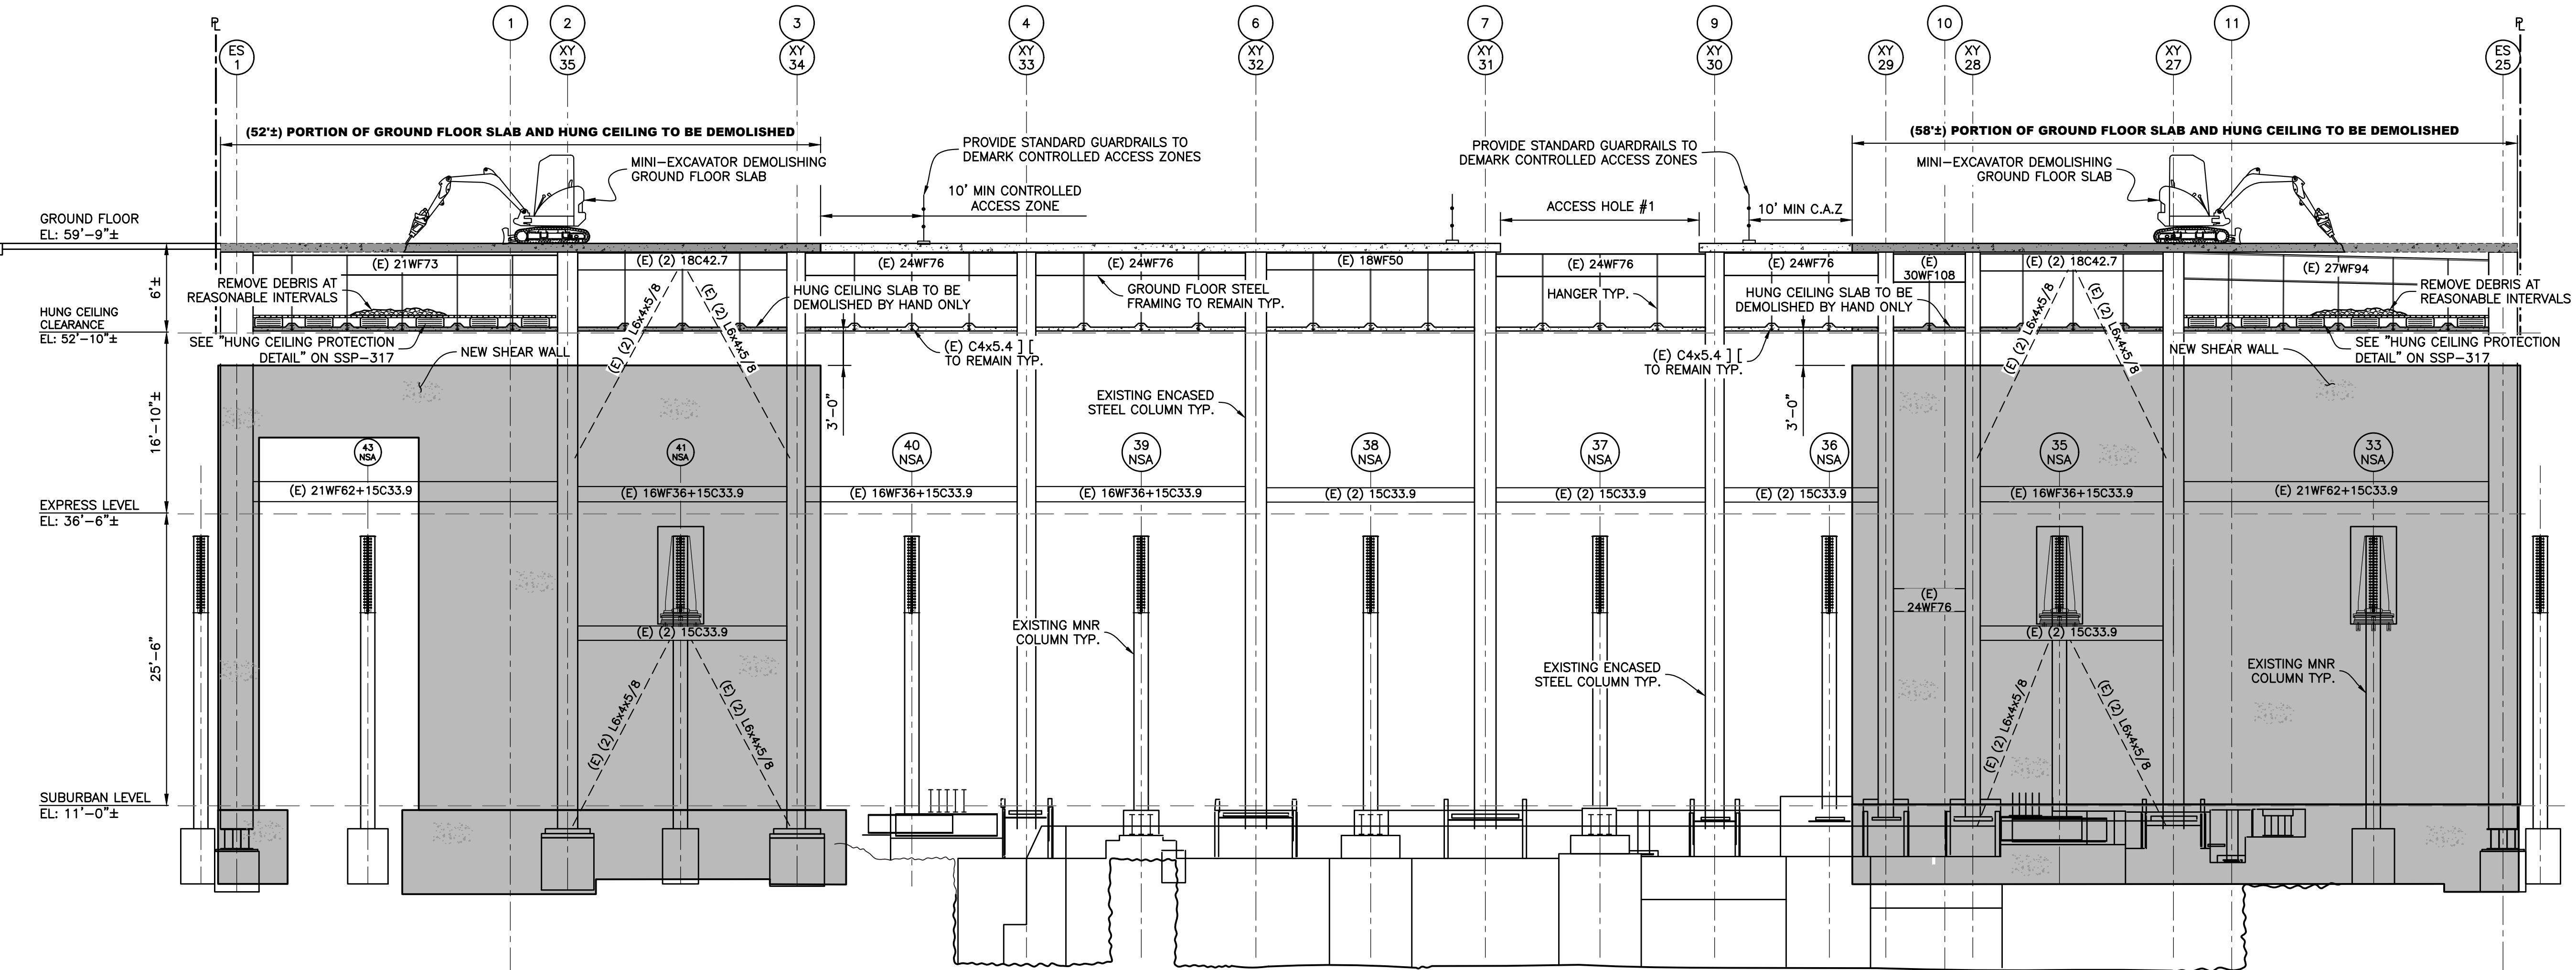


SECTION B-B: SA-LINE SHEAR WALL
Scale: 1/8" = 1'-0"

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ZONING INFORMATION BLOCK: 1283 LOT: 21 ZONE: C5-3 ZONING MAP: 8D COMMUNITY BOARD: 105 BIN #: 1035421			
PLACE STICKER HERE		EXAMINER'S STAMP HERE	
TITLE FLOOR OPENINGS - DEMOLITION SECTIONS A-A & B-B			
SEAL & SIGNATURE Sk Ali-Shafin APPROVED AMENDED PLAN 03/12/2021 CSC SSP	DRAWING BY: KC PROJECT NO: 18211.03.00 ENGINEER: JS SCALE: AS NOTED CHK BY: JS DWG NO:	DATE: 03/04/2021	SSP-314.00

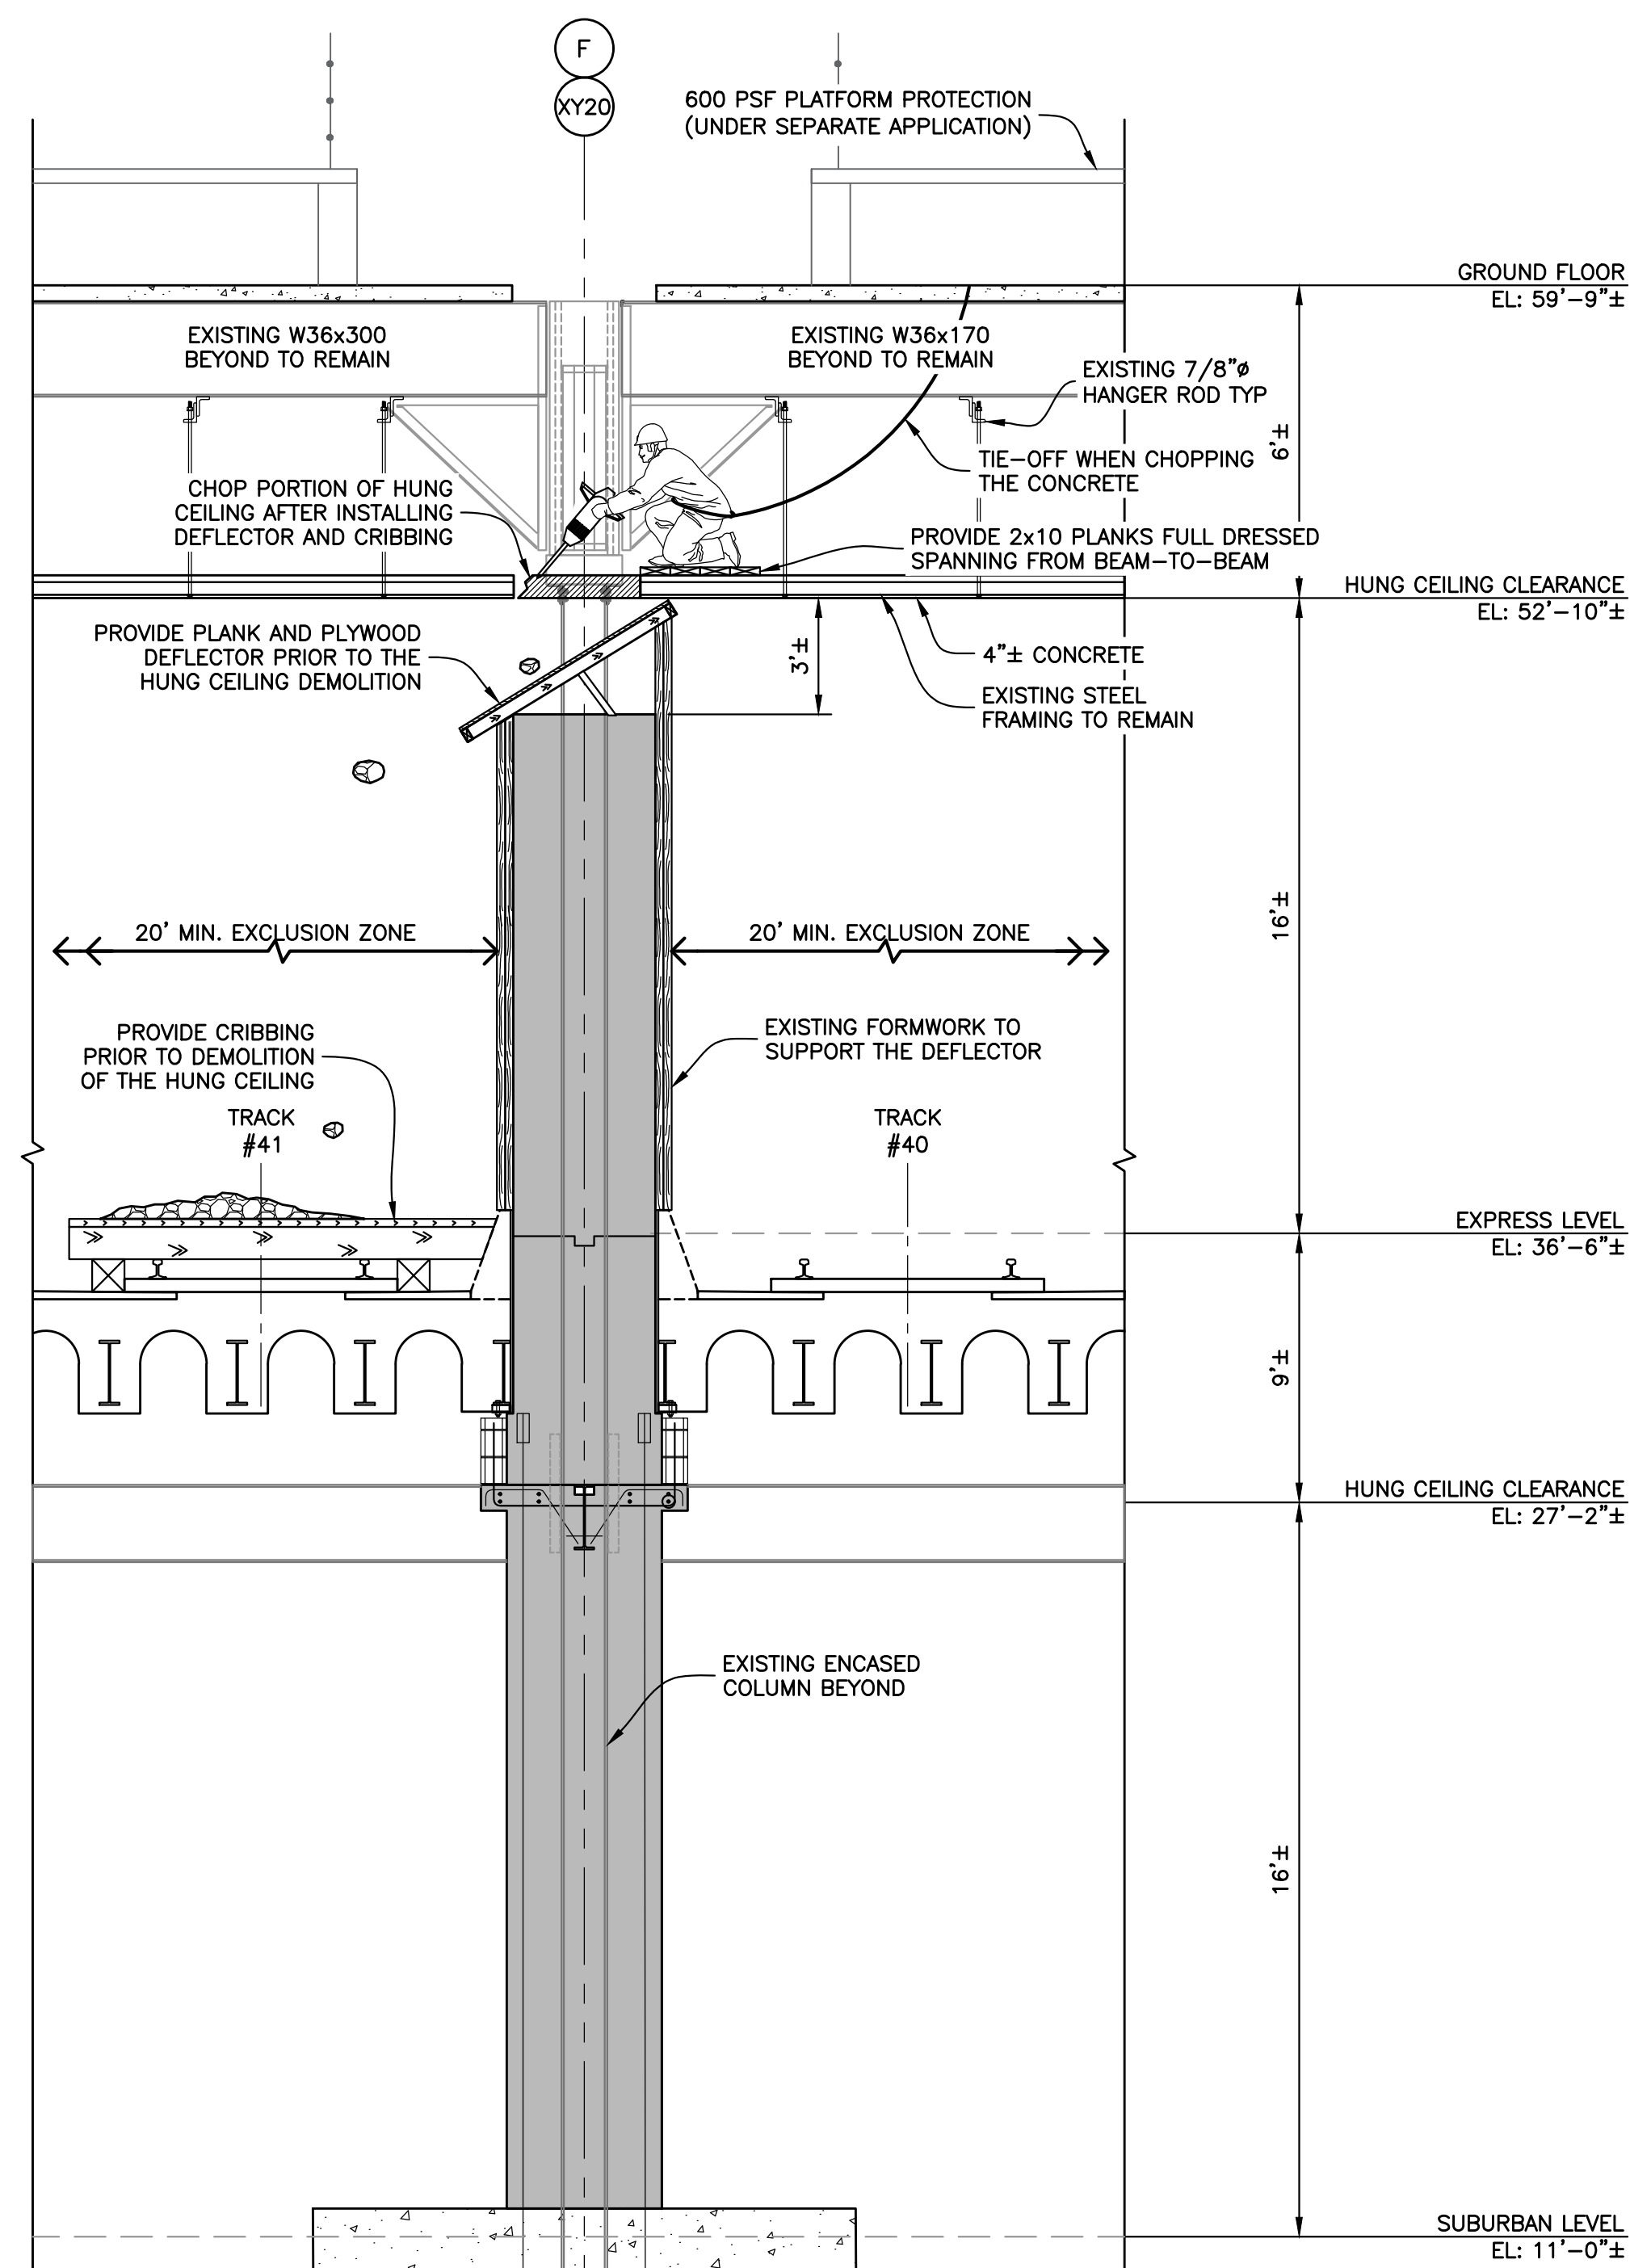


SECTION C-C: F-LINE SHEAR WALL
Scale: 1/4" = 1'-0"

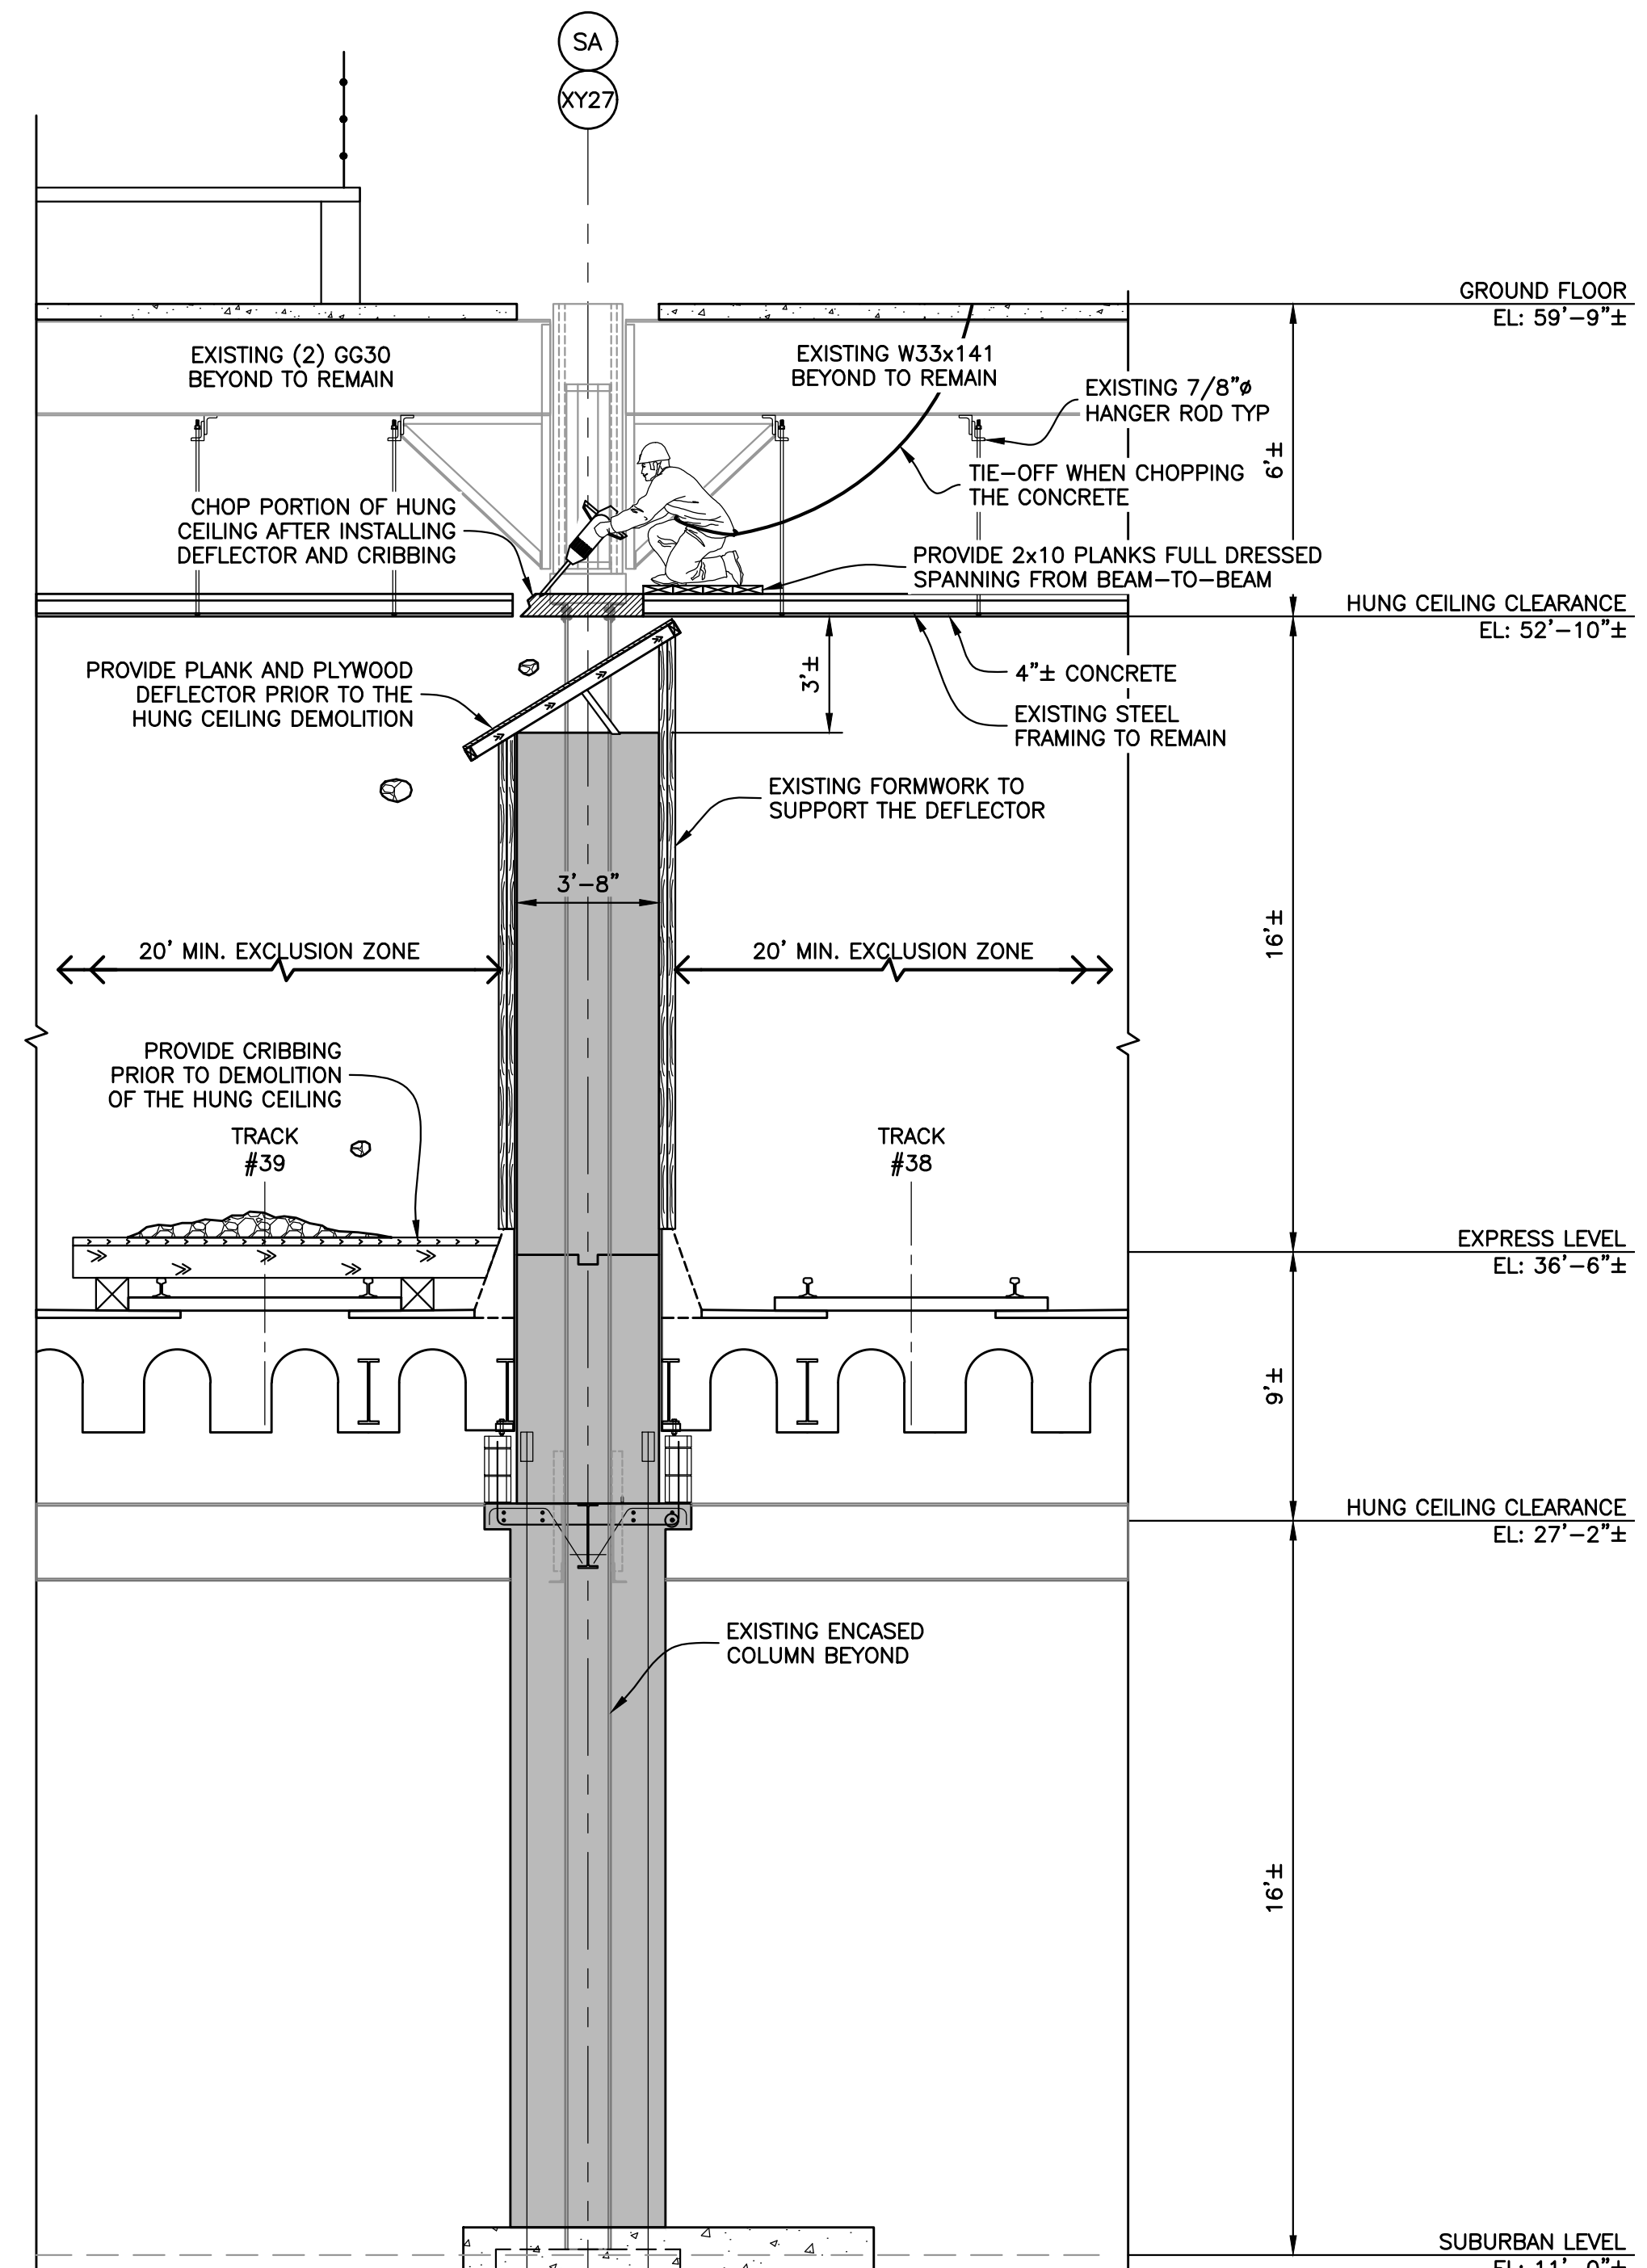


SECTION D-D: SA-LINE SHEAR WALL
Scale: 1/4" = 1'-0"

SEQUENCE 2:

1. PRIOR TO DEMOLISHING THE HUNG CEILING, INSTALL DEFLECTORS ON THE SHEAR WALL 3' BELOW THE HUNG CEILING. CRIBBING SHALL BE INSTALLED ON TRACKS AS PROTECTION FROM FALLING DEBRIS.
2. DEBRIS AND OTHER MATERIAL SHALL BE REMOVED FROM SUCH SLAB AND OTHER ADJACENT FLOOR AREA BEFORE ANY DEMOLITION BEGINS.
3. INSTALL OSHA COMPLIANT TIE-OFF ANCHORS AS NEEDED. PERSONNEL SHALL TIE OFF TO OSHA COMPLIANT TIE POINTS WITH OSHA RATED EQUIPMENT WHEN WITHIN 6' OF THE OPENING.
4. ESTABLISH A MINIMUM OF 20' WIDE EXCLUSION ZONE IN ALL DIRECTIONS BENEATH THE WORK AREA PRIOR TO CHOPPING CONCRETE.
5. PER OSHA, PLANKS NOT LESS THAN 2 INCHES BY 10 INCHES IN CROSS SECTION, FULL SIZE UNDRRESSED, SHALL BE PROVIDED FOR, AND SHALL BE USED BY LABORERS TO STAND ON WHILE CHOPPING SLABS BETWEEN BEAMS. SUCH PLANKS SHALL BE SO LOCATED AS TO PROVIDE A SAFE SUPPORT FOR THE WORKMEN SHOULD THE SLAB BETWEEN THE BEAMS COLLAPSE. THE OPEN SPACE BETWEEN PLANKS SHALL NOT EXCEED 16 INCHES.
SEE "CHOPPING CONCRETE SLAB BY HAND DETAIL" ON SSP-317.
CHOP SLAB BY HAND METHODS ONLY AT THE PORTION OF HUNG CEILING SHOWN IN PLAN. ALL STEEL MEMBERS SHALL BE LEFT INTACT.
6. THE EXISTING HUNG CEILING STEEL FRAMING SHALL REMAIN TO BE CAST INTO THE NEW SHEAR WALL.
7. WHENEVER DEMOLITION CEASES, ANY DEBRIS ON THE TRACK PROTECTION AND WORK AREA SHALL BE CLEANED UP AND REMOVED FROM THE SITE.
8. REFER TO SSP-317 FOR DEMOLITION DETAILS.

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CLIENT JOHN CIVETTA & SONS, INC. 1123 BRONX RIVER AVE, BRONX, NY 10472 PH: (718) 589-9000			
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ZONING INFORMATION BLOCK: 1283 LOT: 21 ZONE: C5-3 ZONING MAP: 8D COMMUNITY BOARD: 105 BIN #: 1035421			
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TITLE FLOOR OPENINGS - DEMOLITION SECTIONS C-C & D-D			
<small>SEAL & SIGNATURE</small>  APPROVED AMENDED PLAN 03/12/2021 CSC SSP		DRAWING BY: KC DATE: 03/04/2021 PROJECT NO: 18211.03.00 ENGINEER: JS SCALE: AS NOTED CHK BY: JS DWG NO:	
		SSP-315.00	

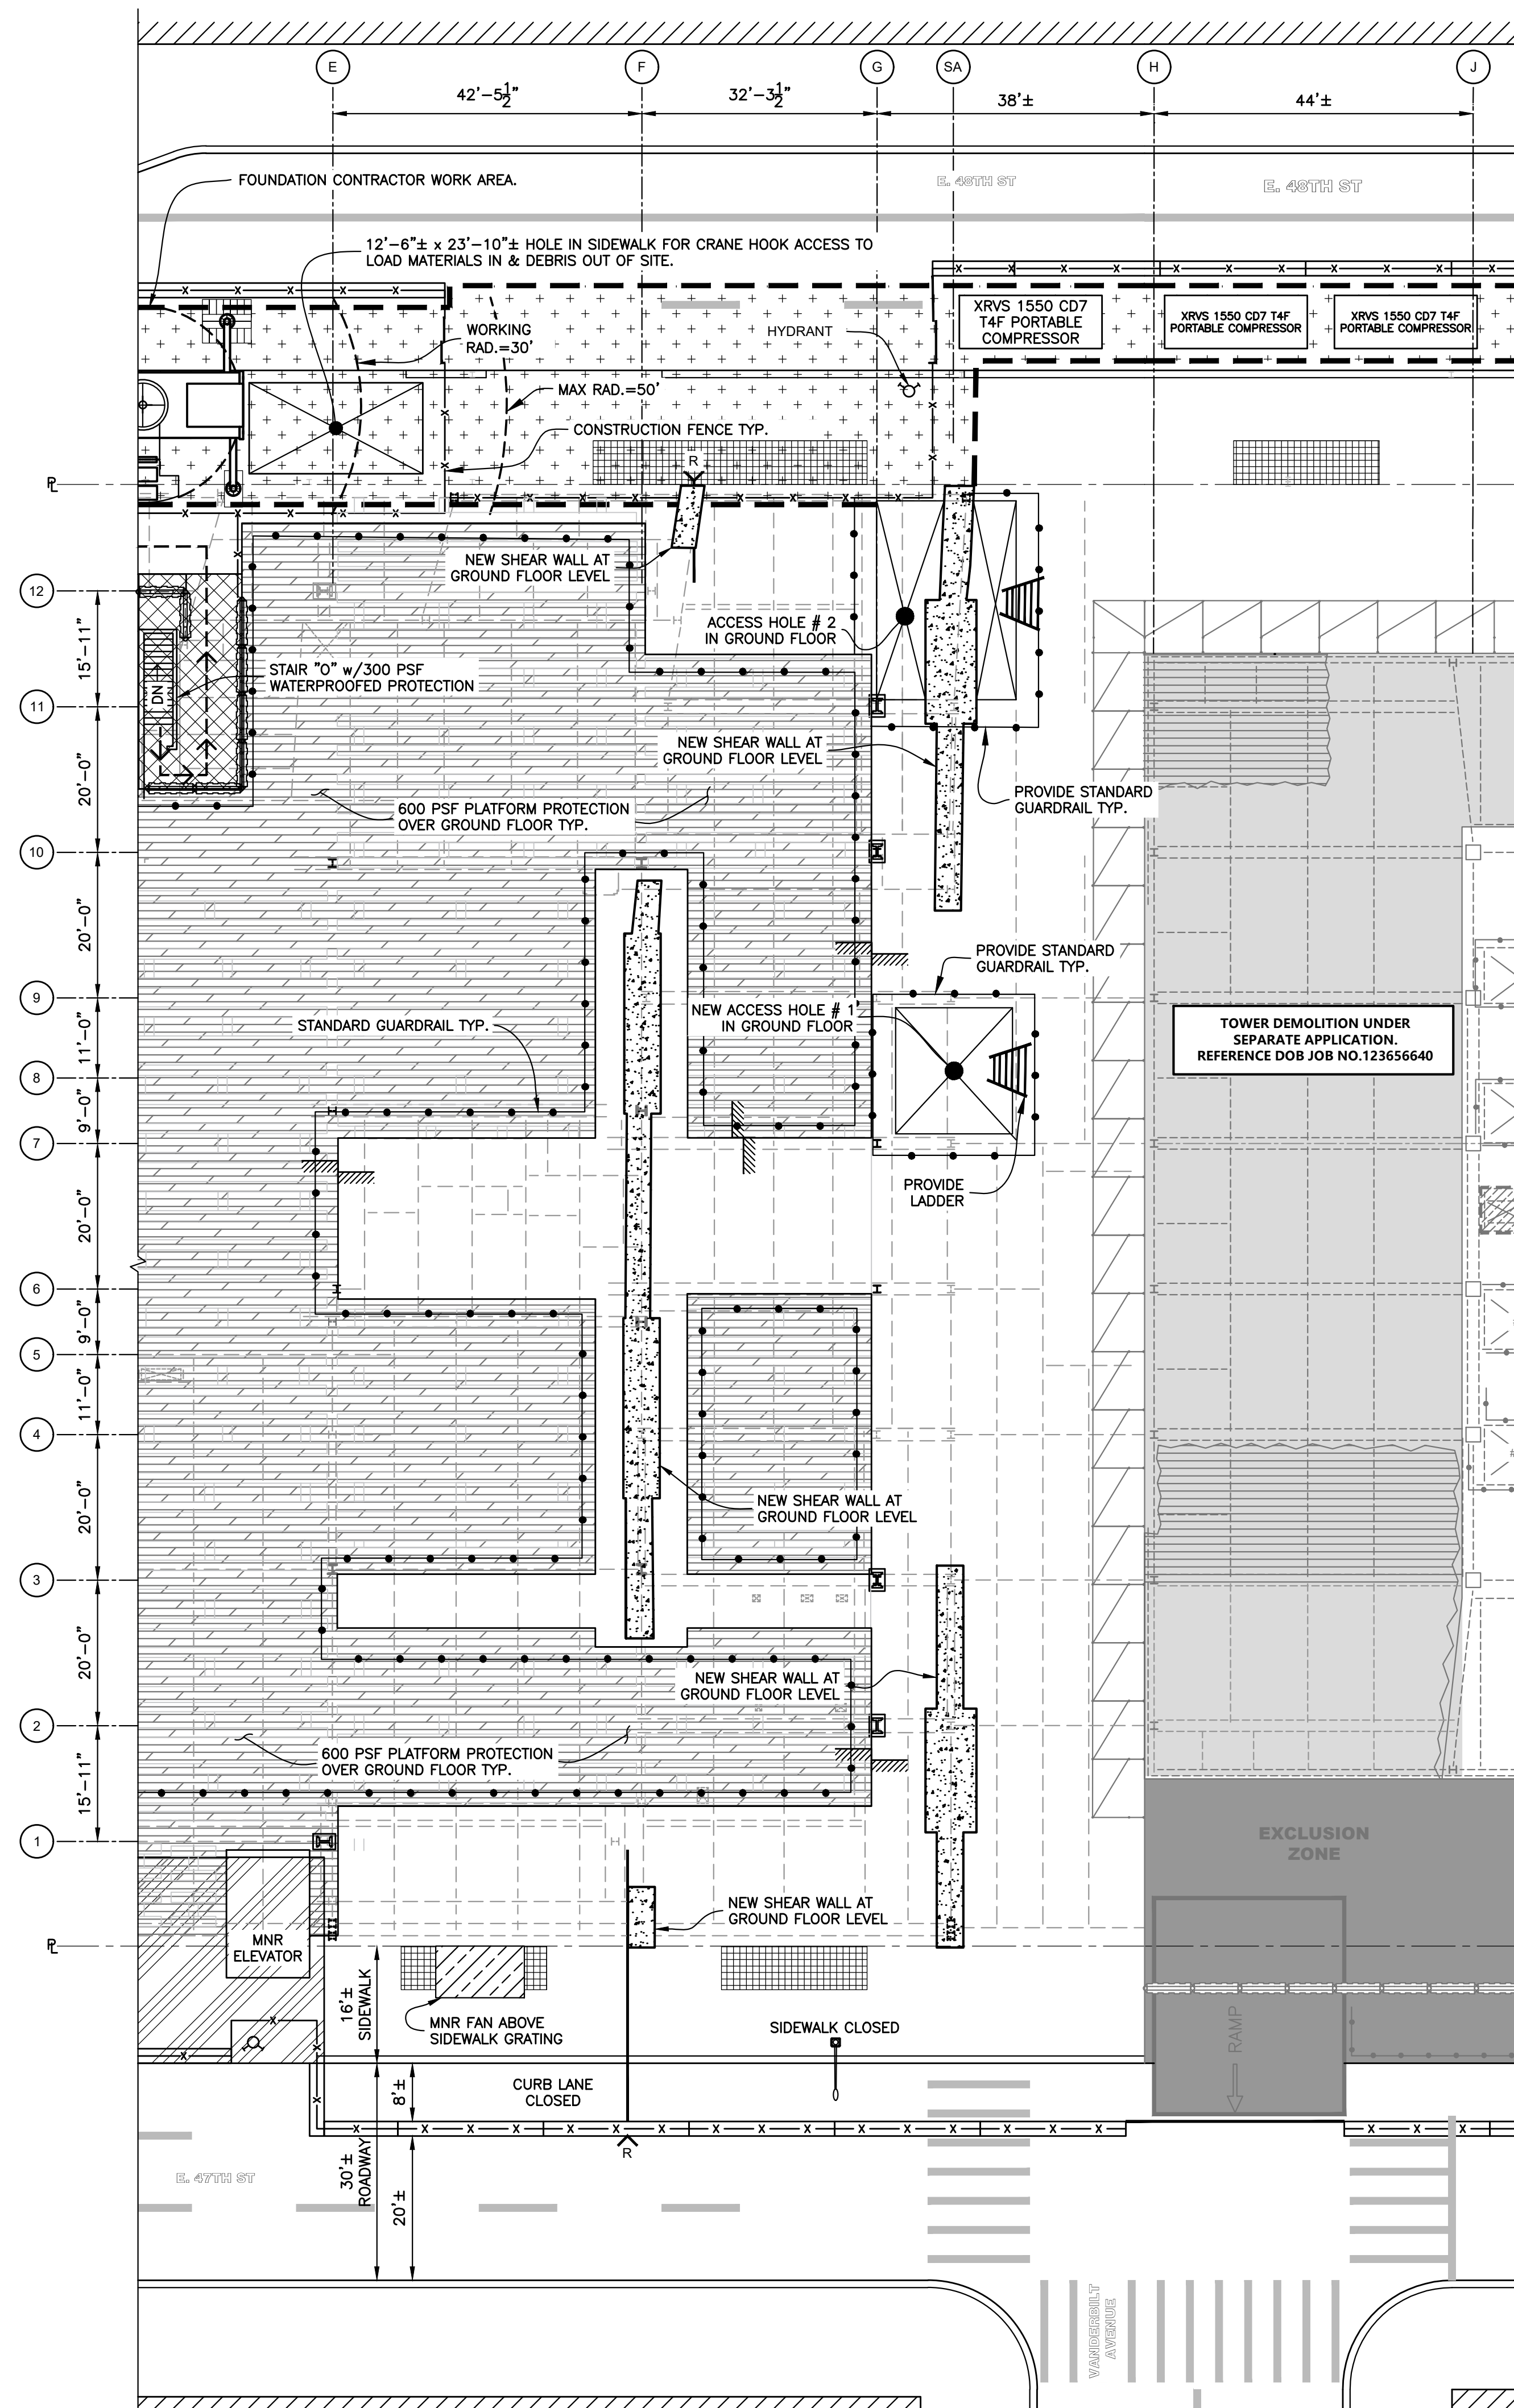


LEGEND	
	NEW SHEAR WALL LEVEL WITH GROUND FLOOR
	FOUNDATION CONTRACTOR WORK AREA TYP.
	600 PSF PLATFORM PROTECTION OVER GROUND FLOOR TYP.
	8' HIGH SIDEWALK SHED TYP.
	STANDARD GUARDRAIL TYP.
	SCAFFOLD w/ GUARDRAIL & DEBRIS NETTING TYP.
	CONCRETE JERSEY BARRIER TYP.
	YODOCKS TYP.

SEQUENCE 3:


1. WHEN DEMOLITION HAS BEEN COMPLETED ALL DEBRIS AND TOOLS SHALL BE CLEANED UP AND REMOVED FROM THE WORK AREA.
2. SHORING, CRIBBING, AND DEFLECTOR CAN BE REMOVED.
3. STANDARD GUARDRAILS SHALL BE PROVIDED AT EXPOSED OPENINGS AS NEEDED.
4. AT THE F-LINE, REPLACE THE PORTIONS OF THE 600 PSF PLATFORM PROTECTION OVER THE GROUND FLOOR.

GROUND FLOOR PARTIAL PLAN
Scale: 1"= 15'-0"

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CLIENT JOHN CIVETTA & SONS, INC. 1123 BRONX RIVER AVE, BRONX, NY 10472 PH: (718) 589-9000			
PROJECT PARTIAL DEMOLITION OF CELLAR SLABS FOR FOUNDATION CONSTRUCTION AT 270 PARK AVENUE, MANHATTAN, NY			
ZONING INFORMATION BLOCK: 1283 LOT: 21 ZONE: C5-3 ZONING MAP: 8D COMMUNITY BOARD: 105 BIN #: 1035421			
PLACE STICKER HERE		EXAMINER'S STAMP HERE	
TITLE FLOOR OPENINGS FINAL SITE CONDITION - PLAN			
SEAL & SIGNATURE APPROVED AMENDED PLAN 03/12/2021 CSC SSP		DRAWING BY: KC DATE: 03/04/2021 PROJECT NO: 18211.03.00 ENGINEER: JS SCALE: AS NOTED CHK BY: JS DWG NO:	
		SSP-316.00	
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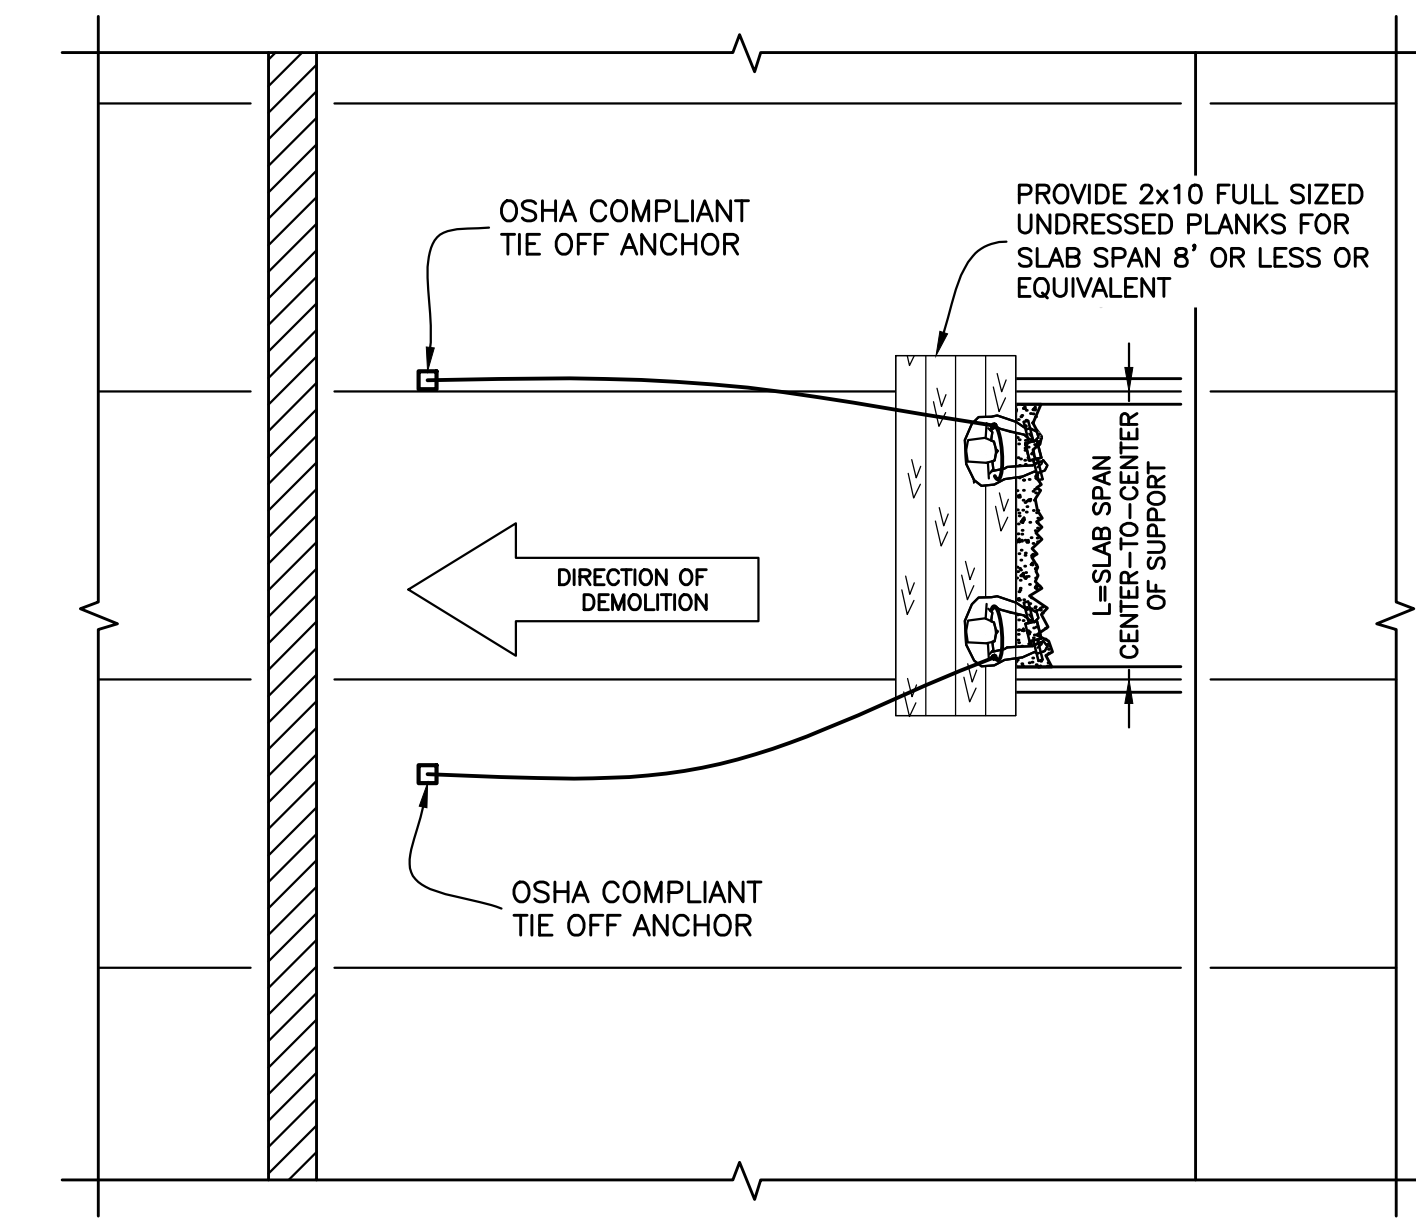


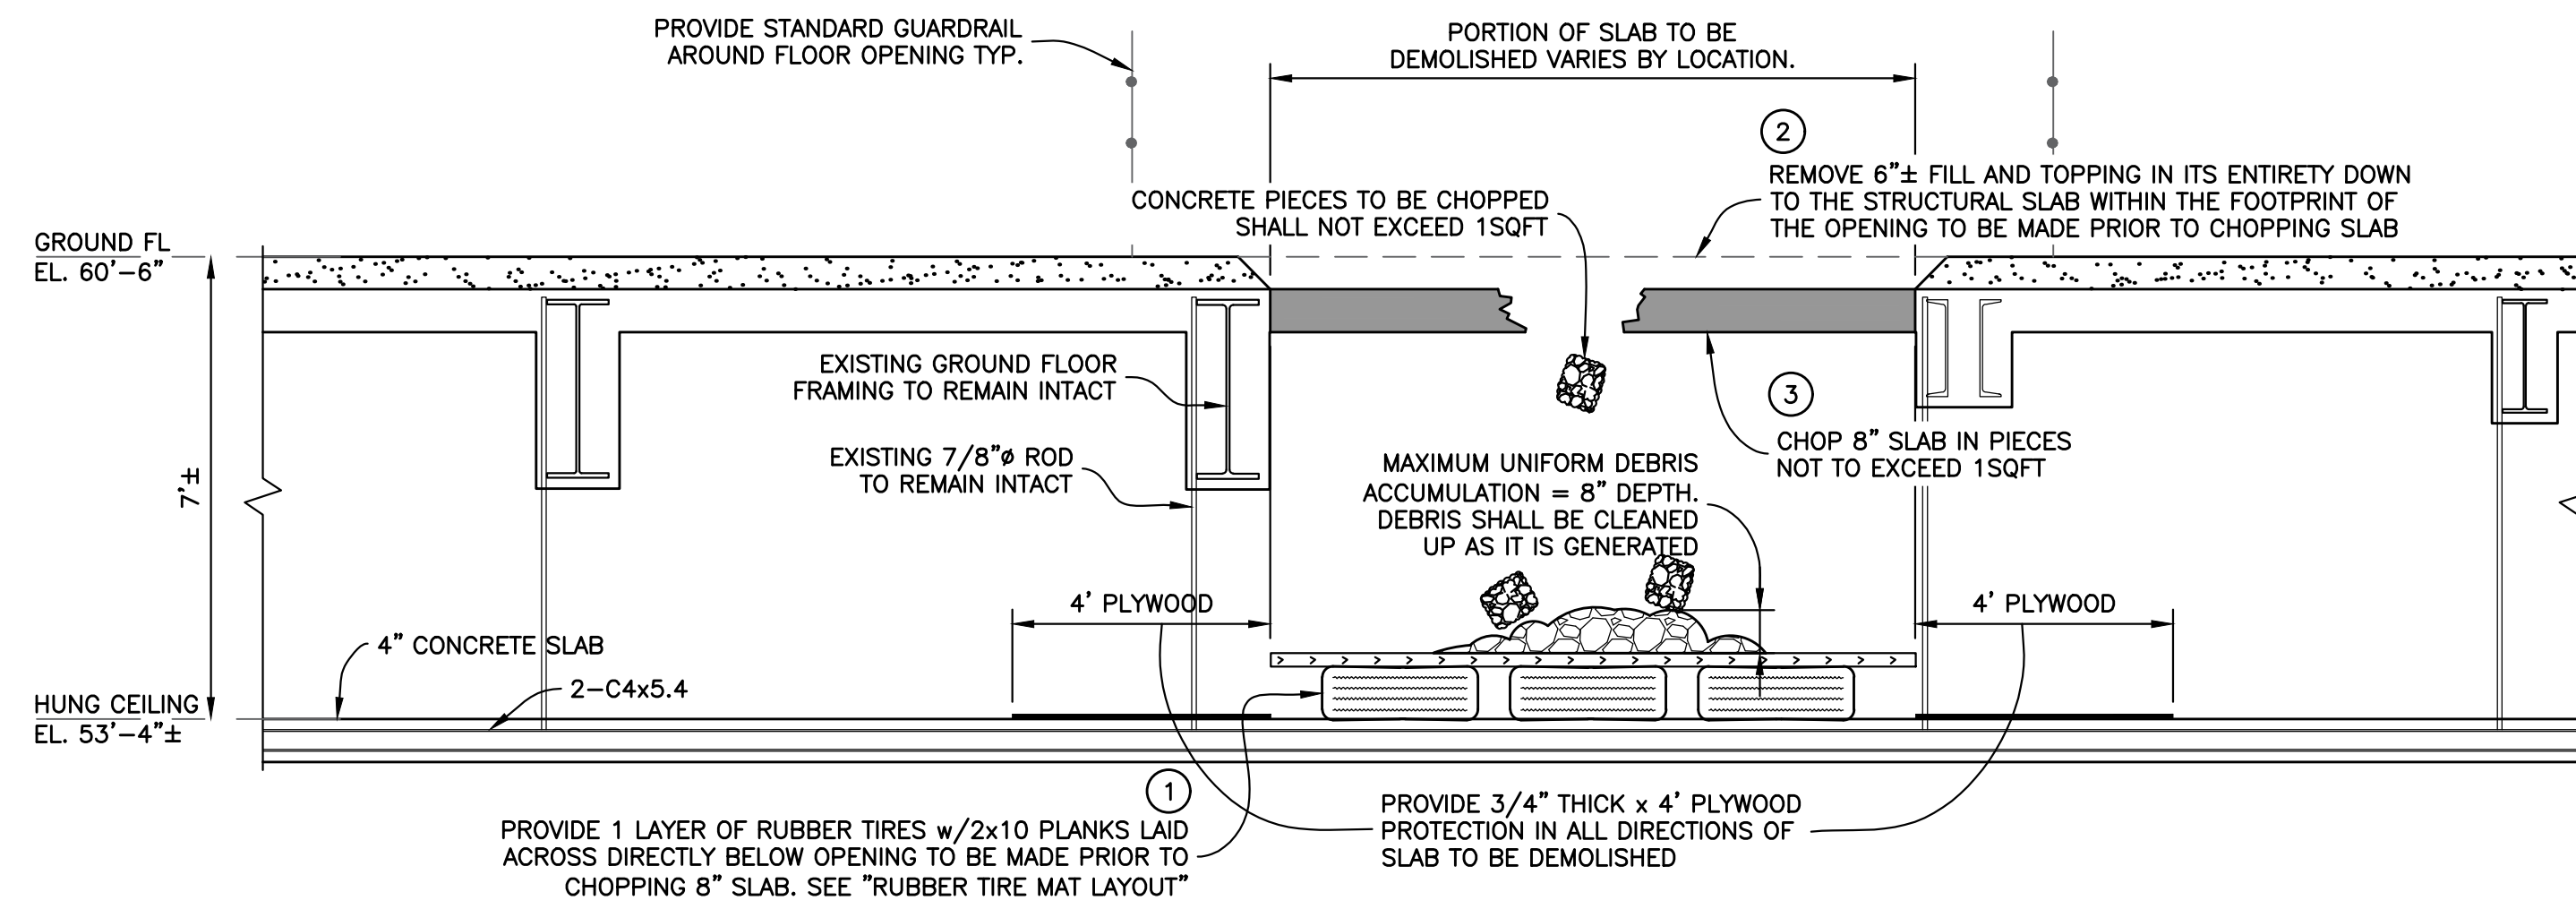HUNG CEILING PROTECTION DETAIL
Scale : 3/8" = 1'-0"

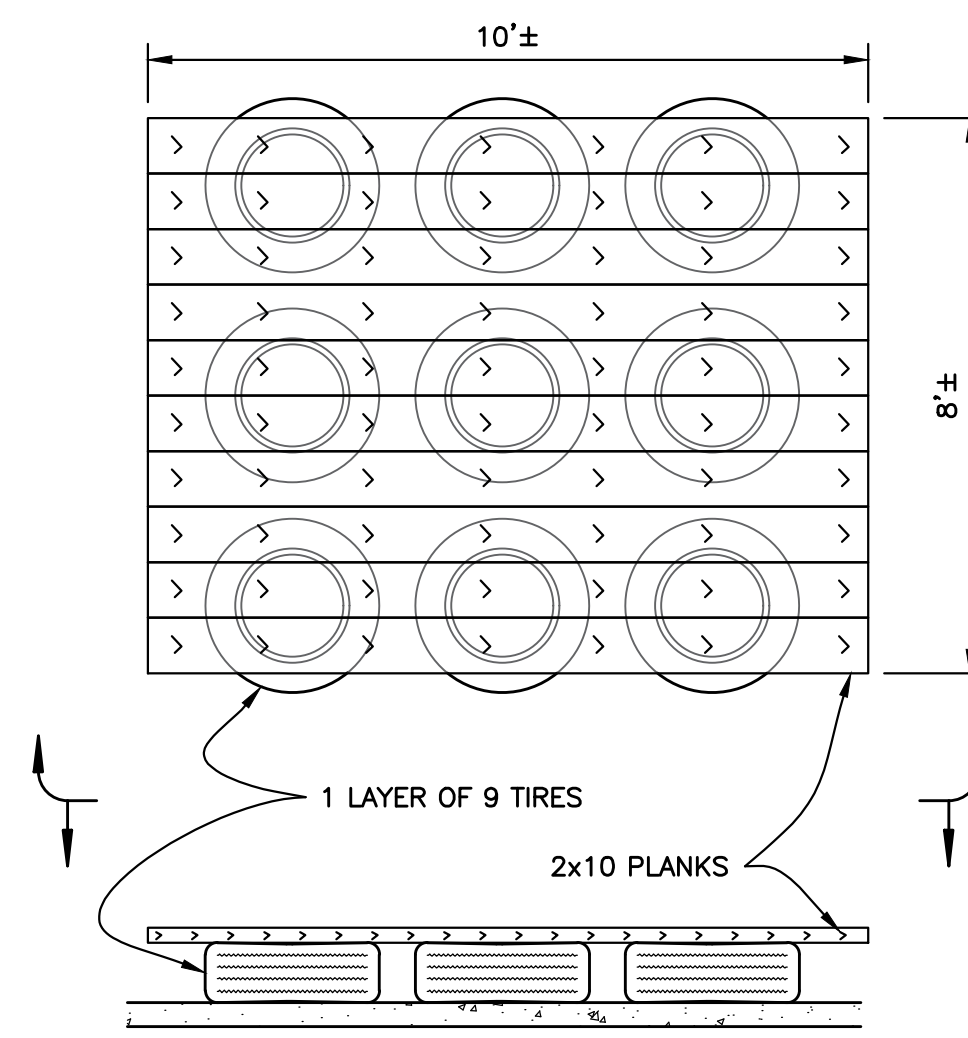

RUBBER TIRE MAT LAYOUT
Scale : 3/8" = 1'-0"


- NOTES:
1. THE MAXIMUM SIZE OF CONCRETE THAT CAN BE DROPPED IS LIMITED TO 100 LBS PIECE IS EQUIVALENT TO A 10"x10"x10" CUBE OR AN 8"x12"x12" PIECE.
FOR GAUGING THE WEIGHT OF IRREGULAR SIZED PIECES, THE PIECE SHALL BE NO HEAVIER THAN WHAT ONE INDIVIDUAL CAN LIFT MANUALLY.
 2. PRIOR TO DEMOLITION, THE HUNG CEILING SHALL BE PROTECTED WITH A LAYER OF RUBBER TIRES w/2x10 PLANKS LAID ACROSS AND A LAYER OF 3/4" THICK PLYWOOD EXTENDING 4' MIN. IN ALL DIRECTIONS OF THE SLAB TO BE DEMOLISHED. SEE "HUNG CEILING PROTECTION DETAIL" AND "RUBBER TIRE MAT LAYOUT" ON THIS SHEET.
 3. THE MAXIMUM DEPTH OF UNIFORMLY DISTRIBUTED DEBRIS ACCUMULATION IS LIMITED TO 8".
REMOVE DEBRIS AT REASONABLE INTERVALS AS IT IS GENERATED.



CHOPPING CONCRETE SLAB BY HAND DETAIL
SCALE : 3/16" = 1'-0"


DEMOLITION PROCEDURE

1. ON THE TWO SUBSEQUENT FLOORS BELOW THE SLAB BEING DEMOLISHED, IN THE AREA WHERE THE CONCRETE DEBRIS WILL BE DROPPED, SITE PERSONNEL SHALL BE MADE AWARE OF THE HAZARDS OF THE DEMOLITION OPERATION AND SHALL NOT BE PERMITTED DIRECTLY UNDER THE AREA BEING DEMOLISHED OR WITHIN 20' OR ONE BAY, WHICHEVER IS GREATER. THESE AREAS ARE 'EXCLUSION ZONES DURING DEMOLITION'. NO PERSONNEL ARE PERMITTED IN THE EXCLUSION ZONES WHILE DEMOLITION IS IN PROGRESS.
2. INSTALL OSHA COMPLIANT TIE OFF ANCHORS AS NEEDED.
3. BEFORE DEMOLISHING ANY SLAB, DEBRIS AND OTHER MATERIAL SHALL BE REMOVED FROM SUCH SLAB AND OTHER ADJACENT FLOOR AREA.
PER OSHA, PLANKS NOT LESS THAN 2 INCHES BY 10 INCHES IN CROSS SECTION, FULL SIZE UNDRRESSED, SHALL BE PROVIDED FOR, AND SHALL BE USED BY LABORERS TO STAND ON WHILE CHOPPING SLABS BETWEEN BEAMS. SUCH PLANKS SHALL BE SO LOCATED AS TO PROVIDE A SAFE SUPPORT FOR THE WORKMEN SHOULD THE SLAB BETWEEN THE BEAMS COLLAPSE. THE OPEN SPACE BETWEEN PLANKS SHALL NOT EXCEED 16 INCHES.
EQUIVALENT ALTERNATIVES TO 2x10 FULL SIZED UNDRRESSED PLANK INCLUDE:
2x10 SCAFFOLD PLANK FOR SPANS LESS THAN OR EQUAL TO 5'.
MINIMUM WIDTH = 2 PLANKS WIDE.
DOUBLE 2x10 SCAFFOLD PLANK FOR SPANS LESS THAN OR EQUAL TO 8'.
MINIMUM WIDTH = 2 PLANKS WIDE.
24" WIDE x 12' LONG ALUMINIUM PICK WITH 5" SIDE RAIL DEPTH AND 2" SIDE RAIL FLANGE (WERNER MODEL 3112) FOR SPANS LESS THAN OR EQUAL TO 10'.
24" WIDE x 16' LONG ALUMINIUM PICK WITH 5" SIDE RAIL DEPTH AND 2" SIDE RAIL FLANGE (WERNER MODEL 3116) FOR SPANS LESS THAN OR EQUAL TO 14'.
PROVIDE MINIMUM 12" BEARING AT EACH END.
CRITERIA IS BASED ON ANSI A10.8 DEFINITION OF A "PERSON LOAD" (200 LB PERSON WITH 50 LBS OF EQUIPMENT). "3-PERSON LOAD" IS APPLIED WITH A "PERSON" LOAD AT MIDSPAN AND A "PERSON" LOAD AT 18" EITHER SIDE OF MIDSPAN.
DEFLECTION ARE LIMITED TO L/60 PER OSHA REQUIREMENTS.
SCAFFOLD PLANK SHALL BE SOUTHERN YELLOW PINE D165 OR 2200f MSR 1.8E GRADE PLANK.
4. PERSONNEL SHALL TIE OFF TO OSHA COMPLIANT TIE POINTS WITH OSHA RATED EQUIPMENT WHEN WITHIN 6' OF THE OPENING.
5. AFTER DEMOLITION IS COMPLETE, INSTALL STANDARD GUARDRAILS AROUND THE OPENING AS FALL PROTECTION OR COVER.

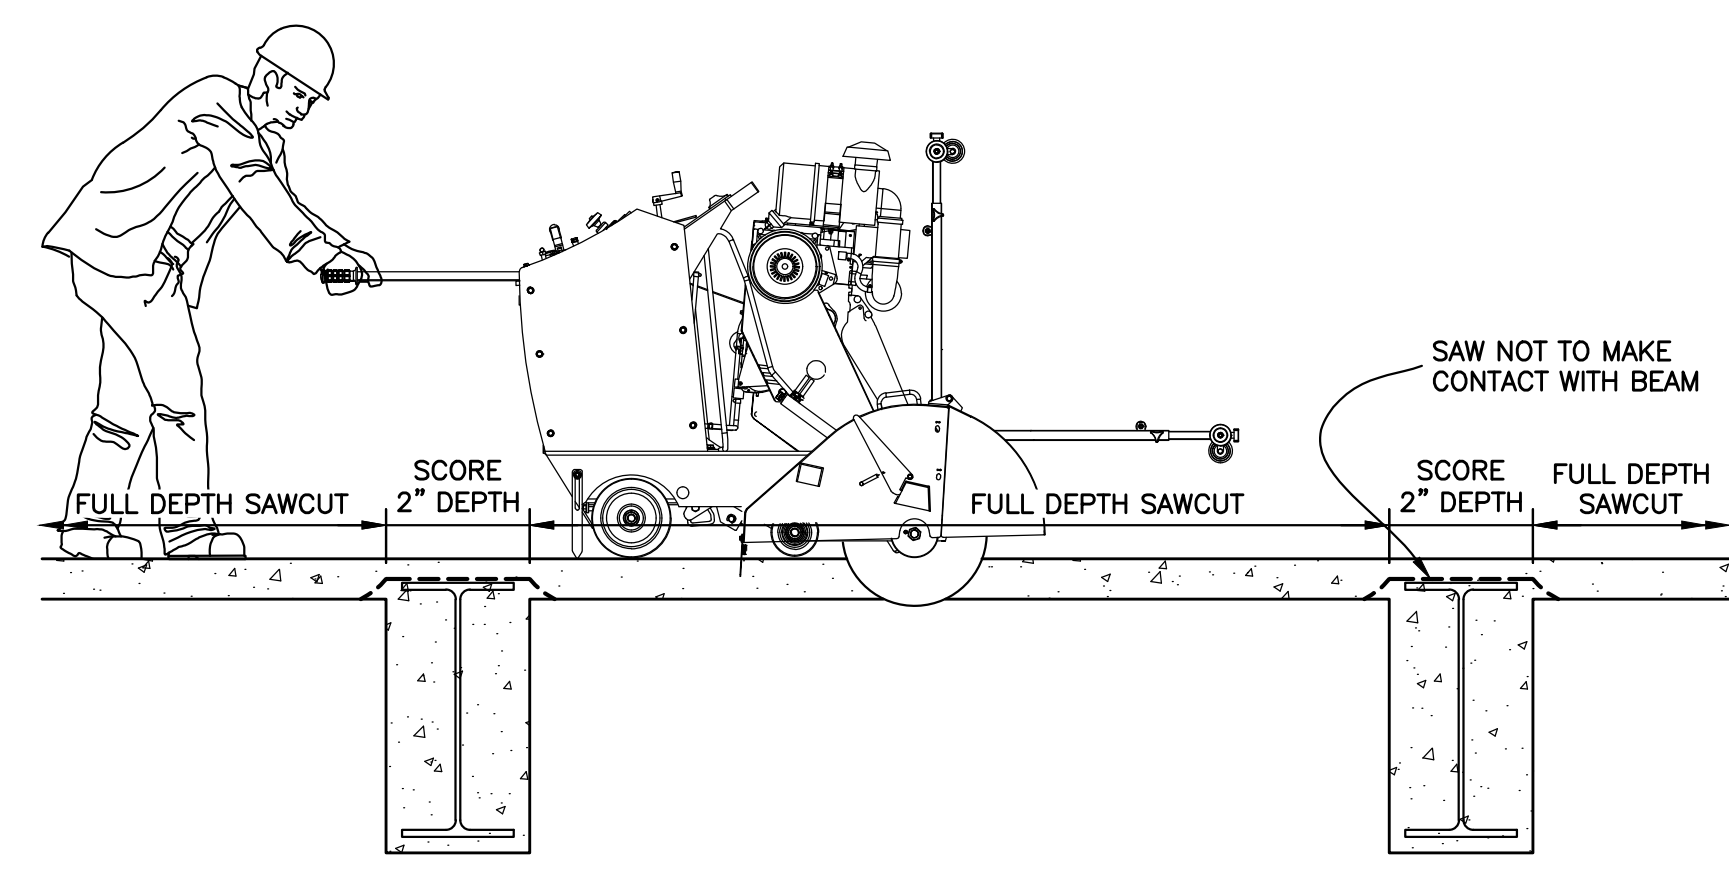


COMBINATION SAWCUT & SCORE DETAIL
Scale : 1/2" = 1'-0"

SCORE SLAB WITH HAND HELD OR WALK BEHIND DEMOLITION SAW. SCORE DEPTH = 2". REDUCE SCORE DEPTH TO PREVENT CONTACT WITH TOP FLANGE OF BEAM.

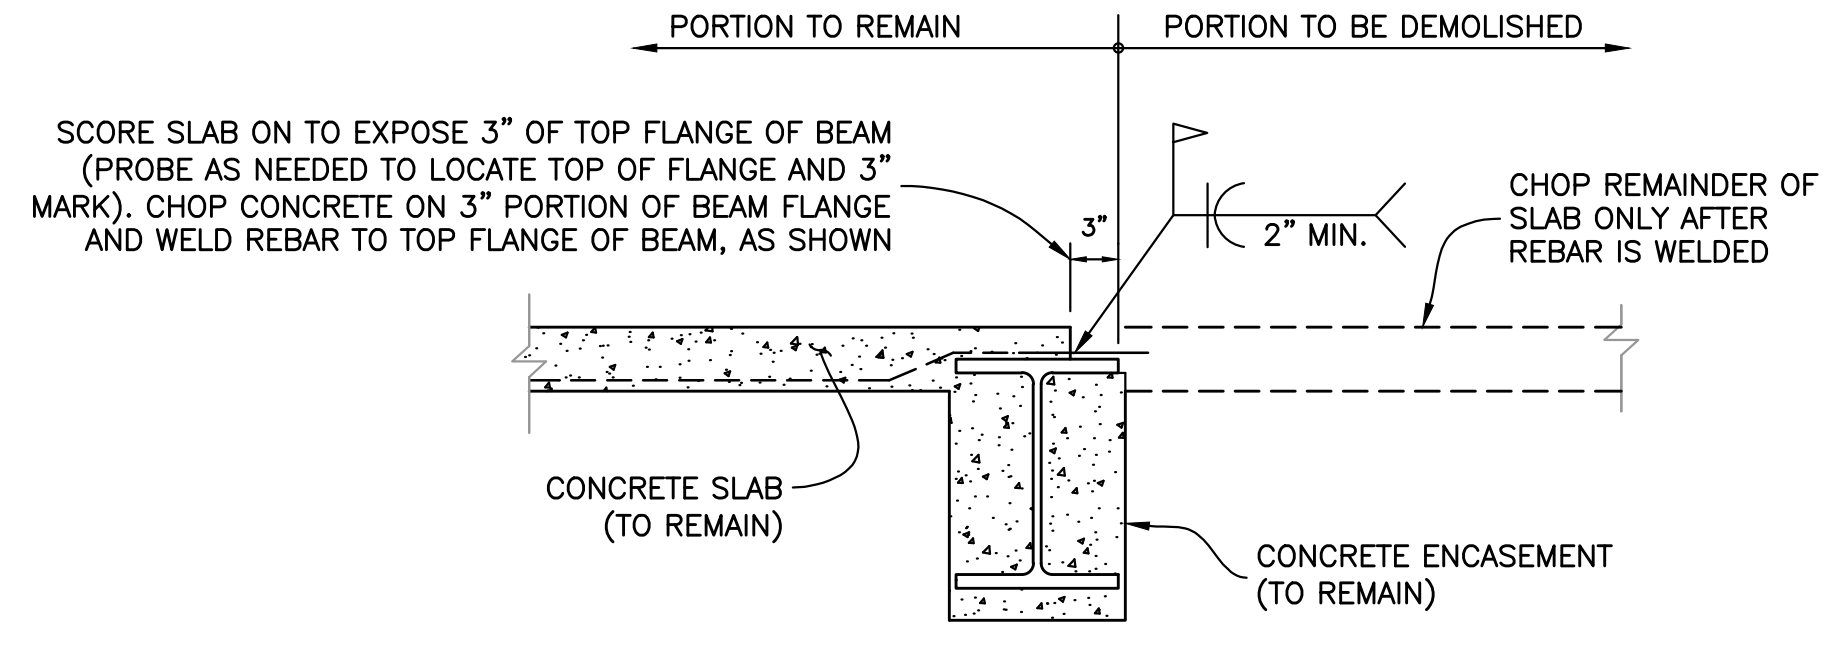

SCORE ONLY DETAIL (WHEN CUT LINE IS OVER A STEEL BEAM)
Scale : 1" = 1'-0"

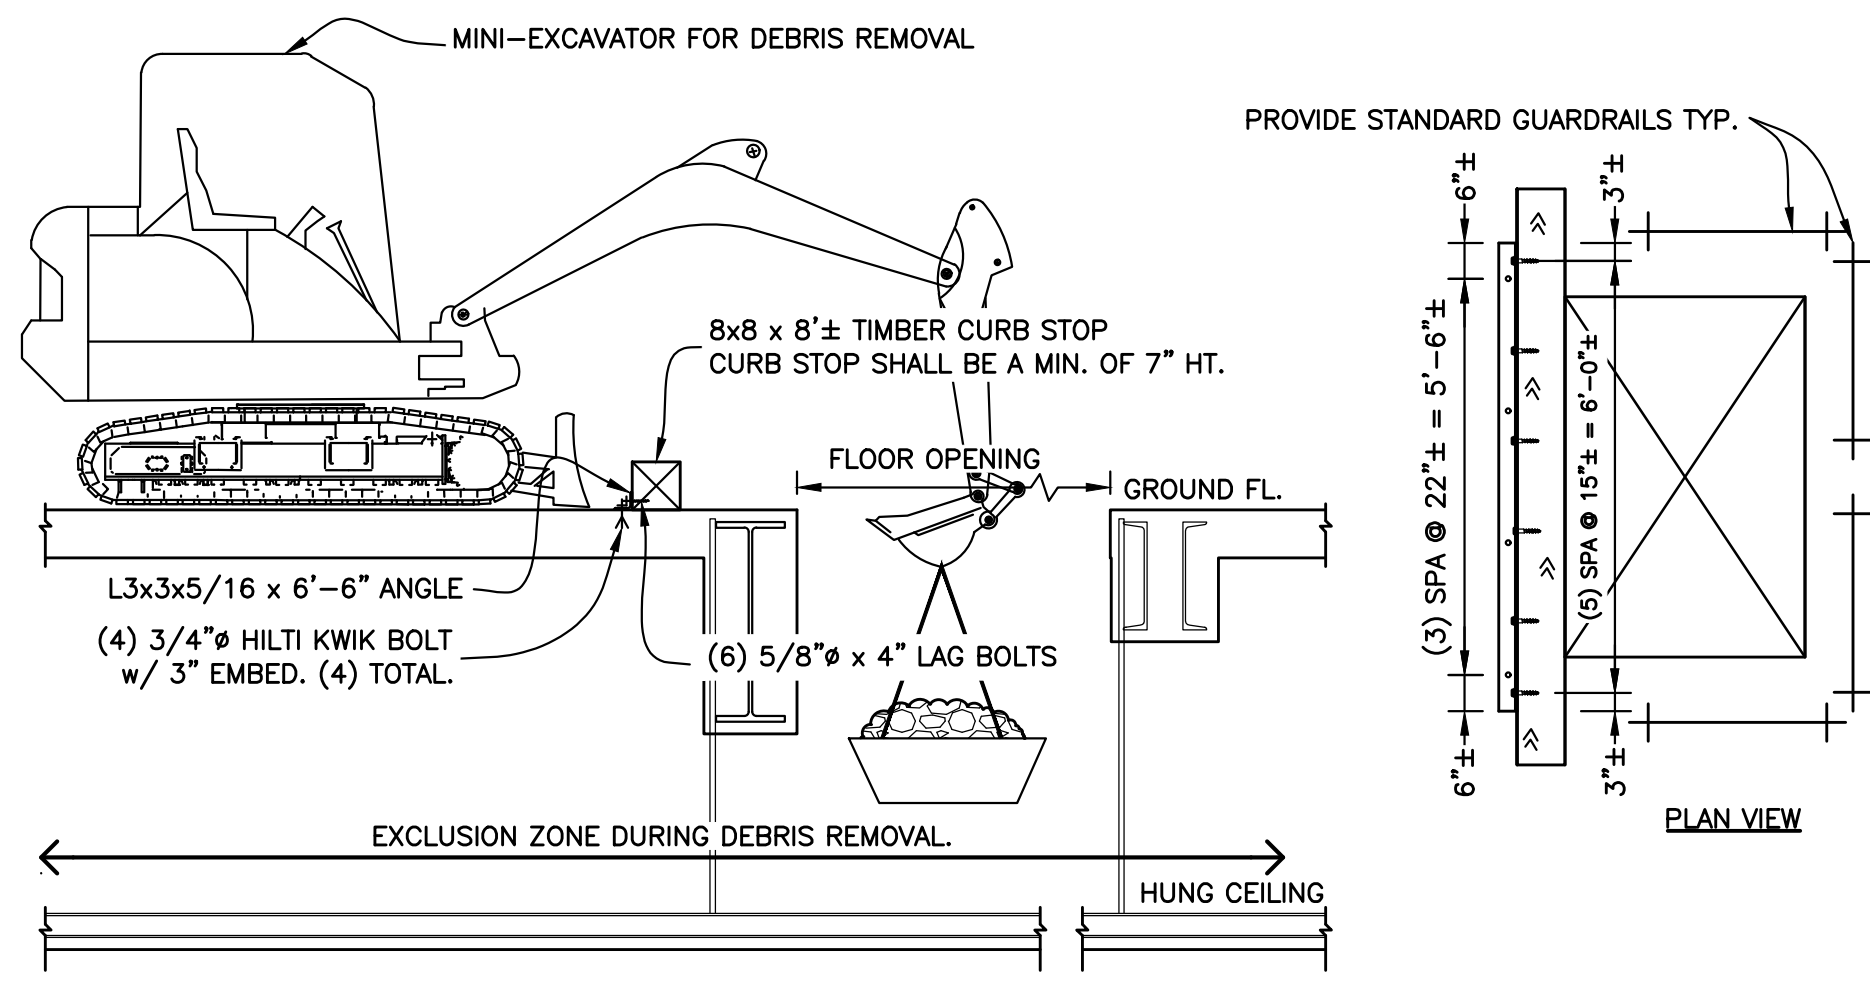

CURB STOP DETAIL - AT FLOOR OPENING
Scale : 3/8" = 1'-0"

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TITLE			
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